THE PAD - MULTI-FAMILY RESIDENTIAL

MULTI-FAMILY RESIDENTIAL | SANDY, OREGON






REPRESENTATIONAL IMAGE. IMAGE SHOWN MAY NOT BE AN EXACT REPRESENTATION OF ACTUAL DESIGN AND CONSTRUCTION.

Anifarm Cafe and Bakery Sandy Decor Thrive Fitness Mountain Moka Tree Bird Ace Heritage Hardware Date Service Ace Heritage Hardware Date Service Double Gragon Mt Hood Home Date Service Ace Heritage Hardware Date Service Double Gragon Pioneer Bird Pacific Hardware Date Service Pioneer Bird Project Location Project Location Red Coocle Project Location Project Location N N Coocle Project Location Project Location N N

VICINITY MAP

SCALE: NTS

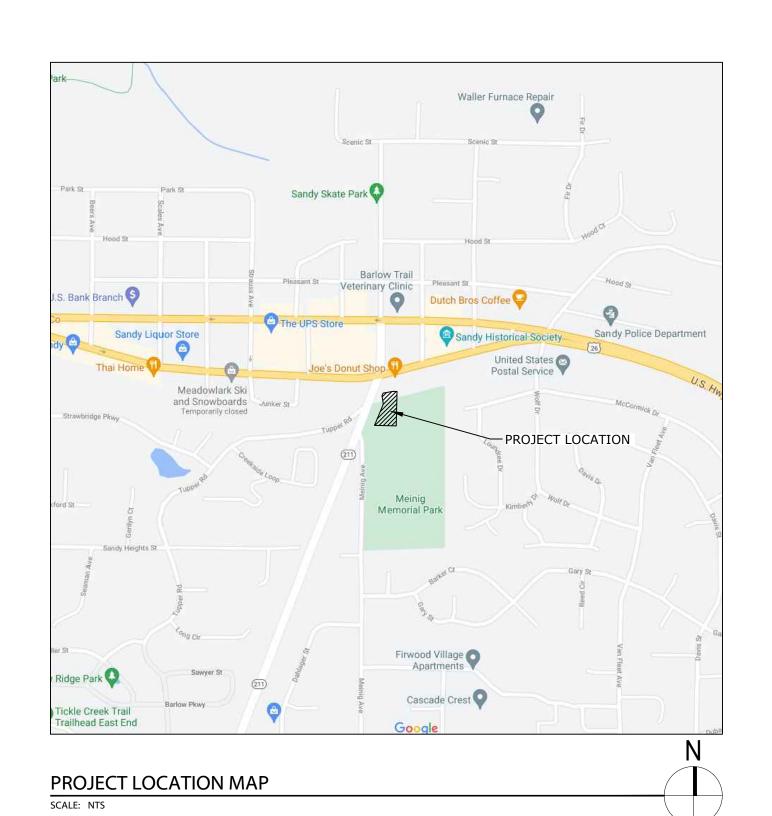

PROJECT DESCRIPTION

REDEVELOPMENT OF AN EXISTING LOT INTO A MULTI-FAMILY COMPLEX CONSISTING OF TEN 2-STORY UNITS OCCUPYING 2 BUILDINGS. OUTDOOR RECREATIONAL AREAS AS WELL AS PARKING, AND VEHICLE AND PEDESTRIAN CIRCULATION SYSTEMS WILL ALSO BE INSTALLED.

SITE INFORMATION

ADDRESS:	17650 MEINIG ACENUE SANDY, OR 97055
PARCEL NUMBER:	00663758
TAX LOT NUMBER:	24E13DB01500
COUNTY:	CLACKAMAS COUNTY
JURISDICTION:	CITY OF SANDY
FIRE DISTRICT:	SANDY FIRE DISTRICT NO. 72
ZONING:	R3 - HIGH DENSITY RESIDENTIAL
DESCRIPTION OF USE:	MULTI-FAMILY RESIDENTIAL
AREA (APPROX.):	PROPERTY: 25,869 S.F. (0.59 ACRES)

PROJECT TEAM

OWNER:	OWNER NAME
	STREET ADDRESS
	CITY, STATE ZIP CODE
	PHONE: (###) ###-####
	CONTACT: FIRST LAST NAME
ARCHITECT:	AXIS DESIGN GROUP
	ARCHITECTURE & ENGINEERING, INC.
	11104 S.E. STARK STREET
	PORTLAND, OR 97216
	PHONE: (503) 284-0988
	CONTACT: FIRST LAST NAME
CIVIL:	KURAHASHI & ASSOCIATES
	4470 SW HALL BLVD.
	CLIITE C

LANDSCAPE: JOYCE JACKSON - LANDSCAPE ARCHITECT 1940 SYLVAN WAY

BEAVERTON, OR 97005

PHONE: (503) 267-8434

1940 SYLVAN WAY WEST LINN, OR 97068 PHONE: (503) 703-8607 CONTACT: JOYCE JACKSON

SHEET INDEX

SHEET NUMBER	SHEET TITLE	DESIGN REVIEW	MILESTONE
SHEET NOWIDER	SHEET TITLE		
GENERAL			
G-000	COVER SHEET, SITE INFO, SHEET INDEX	Х	
CIVIL			
C-1	EXISTING CONDITIONS	Х	
C-2	CIVIL SITE PLAN	Х	
C-3	UTILITY PLAN	Х	
C-4	GRADING PLAN	Х	
C-5	TREE PRESERVATION PLAN	Х	
LANDSCAPE			
L-1	PLANTING PLAN	X	
L-2	LANDSCAPE NOTES AND DETAILS	X	
ARCHITECTURAL			
A-101	SITE PLAN - EXISTING/DEMO	Х	
A-102	SITE PLAN - PROPOSED	Х	
A-201	FIRST AND SECOND FLOOR PLANS - PROPOSED	Х	
A-221	EXTERIOR ELEVATIONS - BUILDING "A" - PROPOSED	Х	
A-222	EXTERIOR ELEVATIONS - BUILDING "B" - PROPOSED	Х	
	I .		
SITE LIGHTING			

EGEND:

x = ISSUED AS PART OF SET $\Diamond = NOT$ PART OF ISSUED SET

* = ISSUED FOR INFORMATION ONLY

JOB NO: 20-004

DATE: 07/16/2021

DRAWN BY: SJM


DATE: 07/16/2021
ISSUED FOR: DESIGN REVIEW

SHEET TITLE
SHEET INDEX,


PROJECT DESCRIPTION,
SITE INFORMATION, AND
PROJECT TEAM

SHEET NO.

G-000

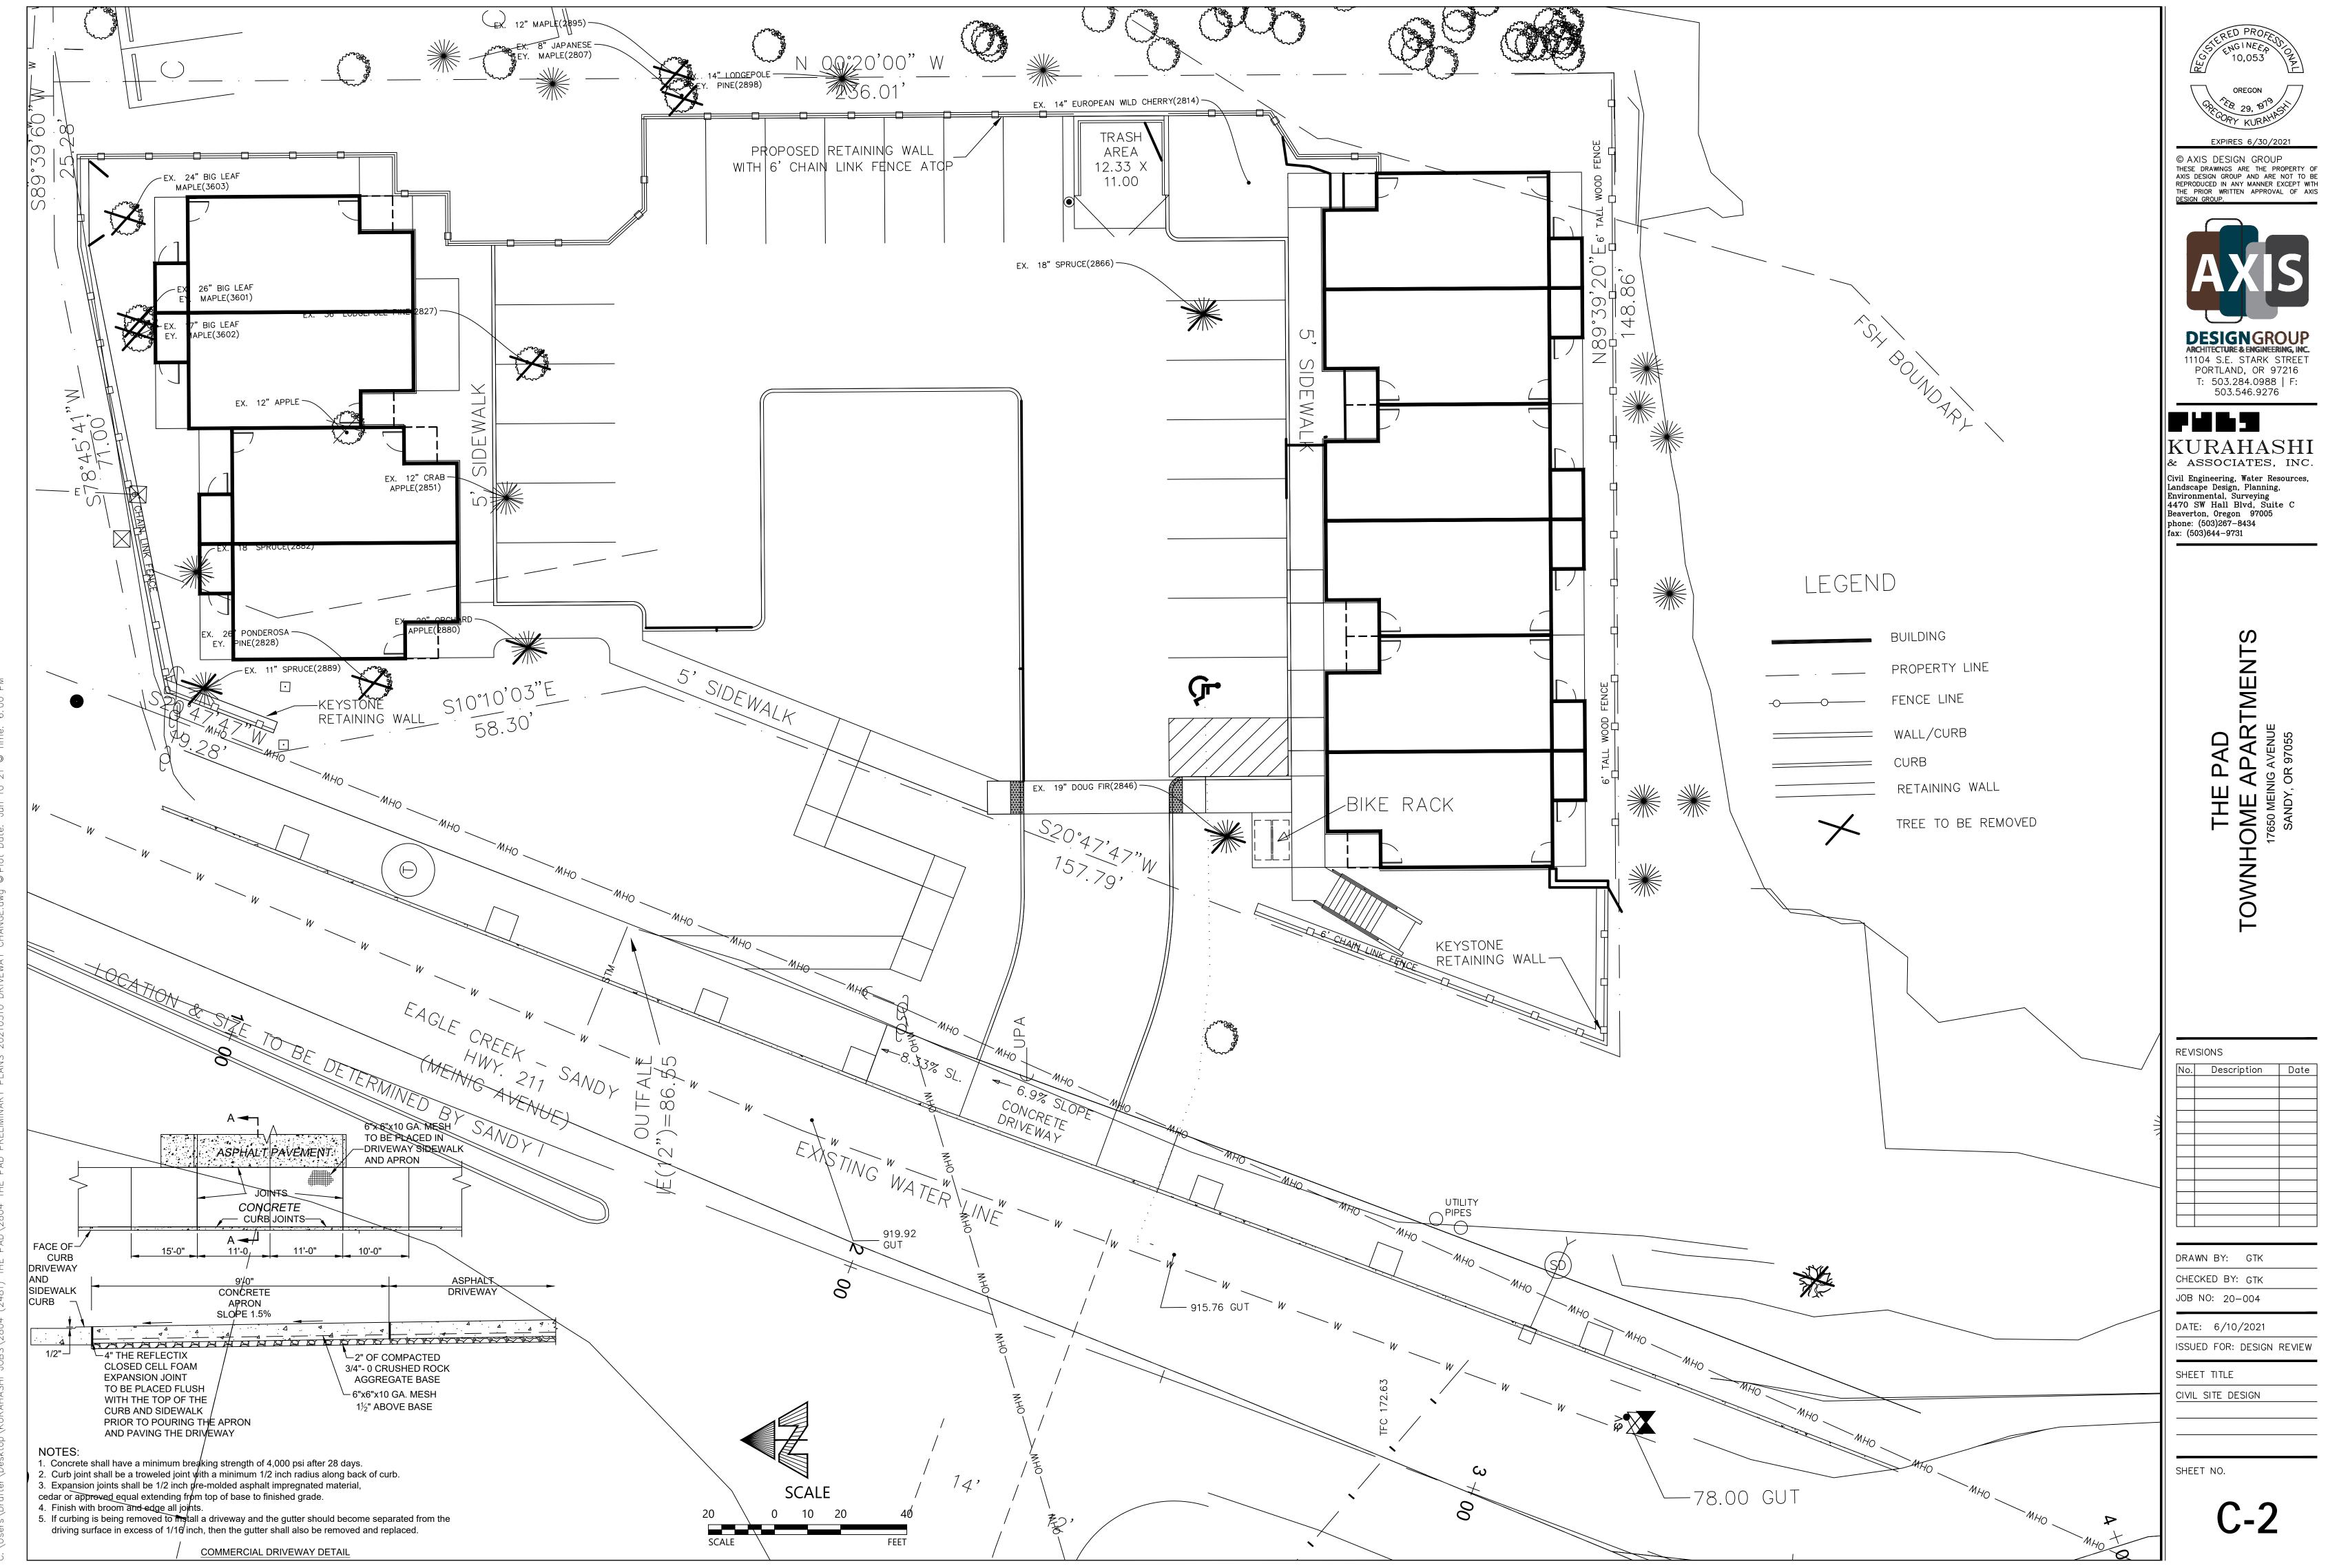



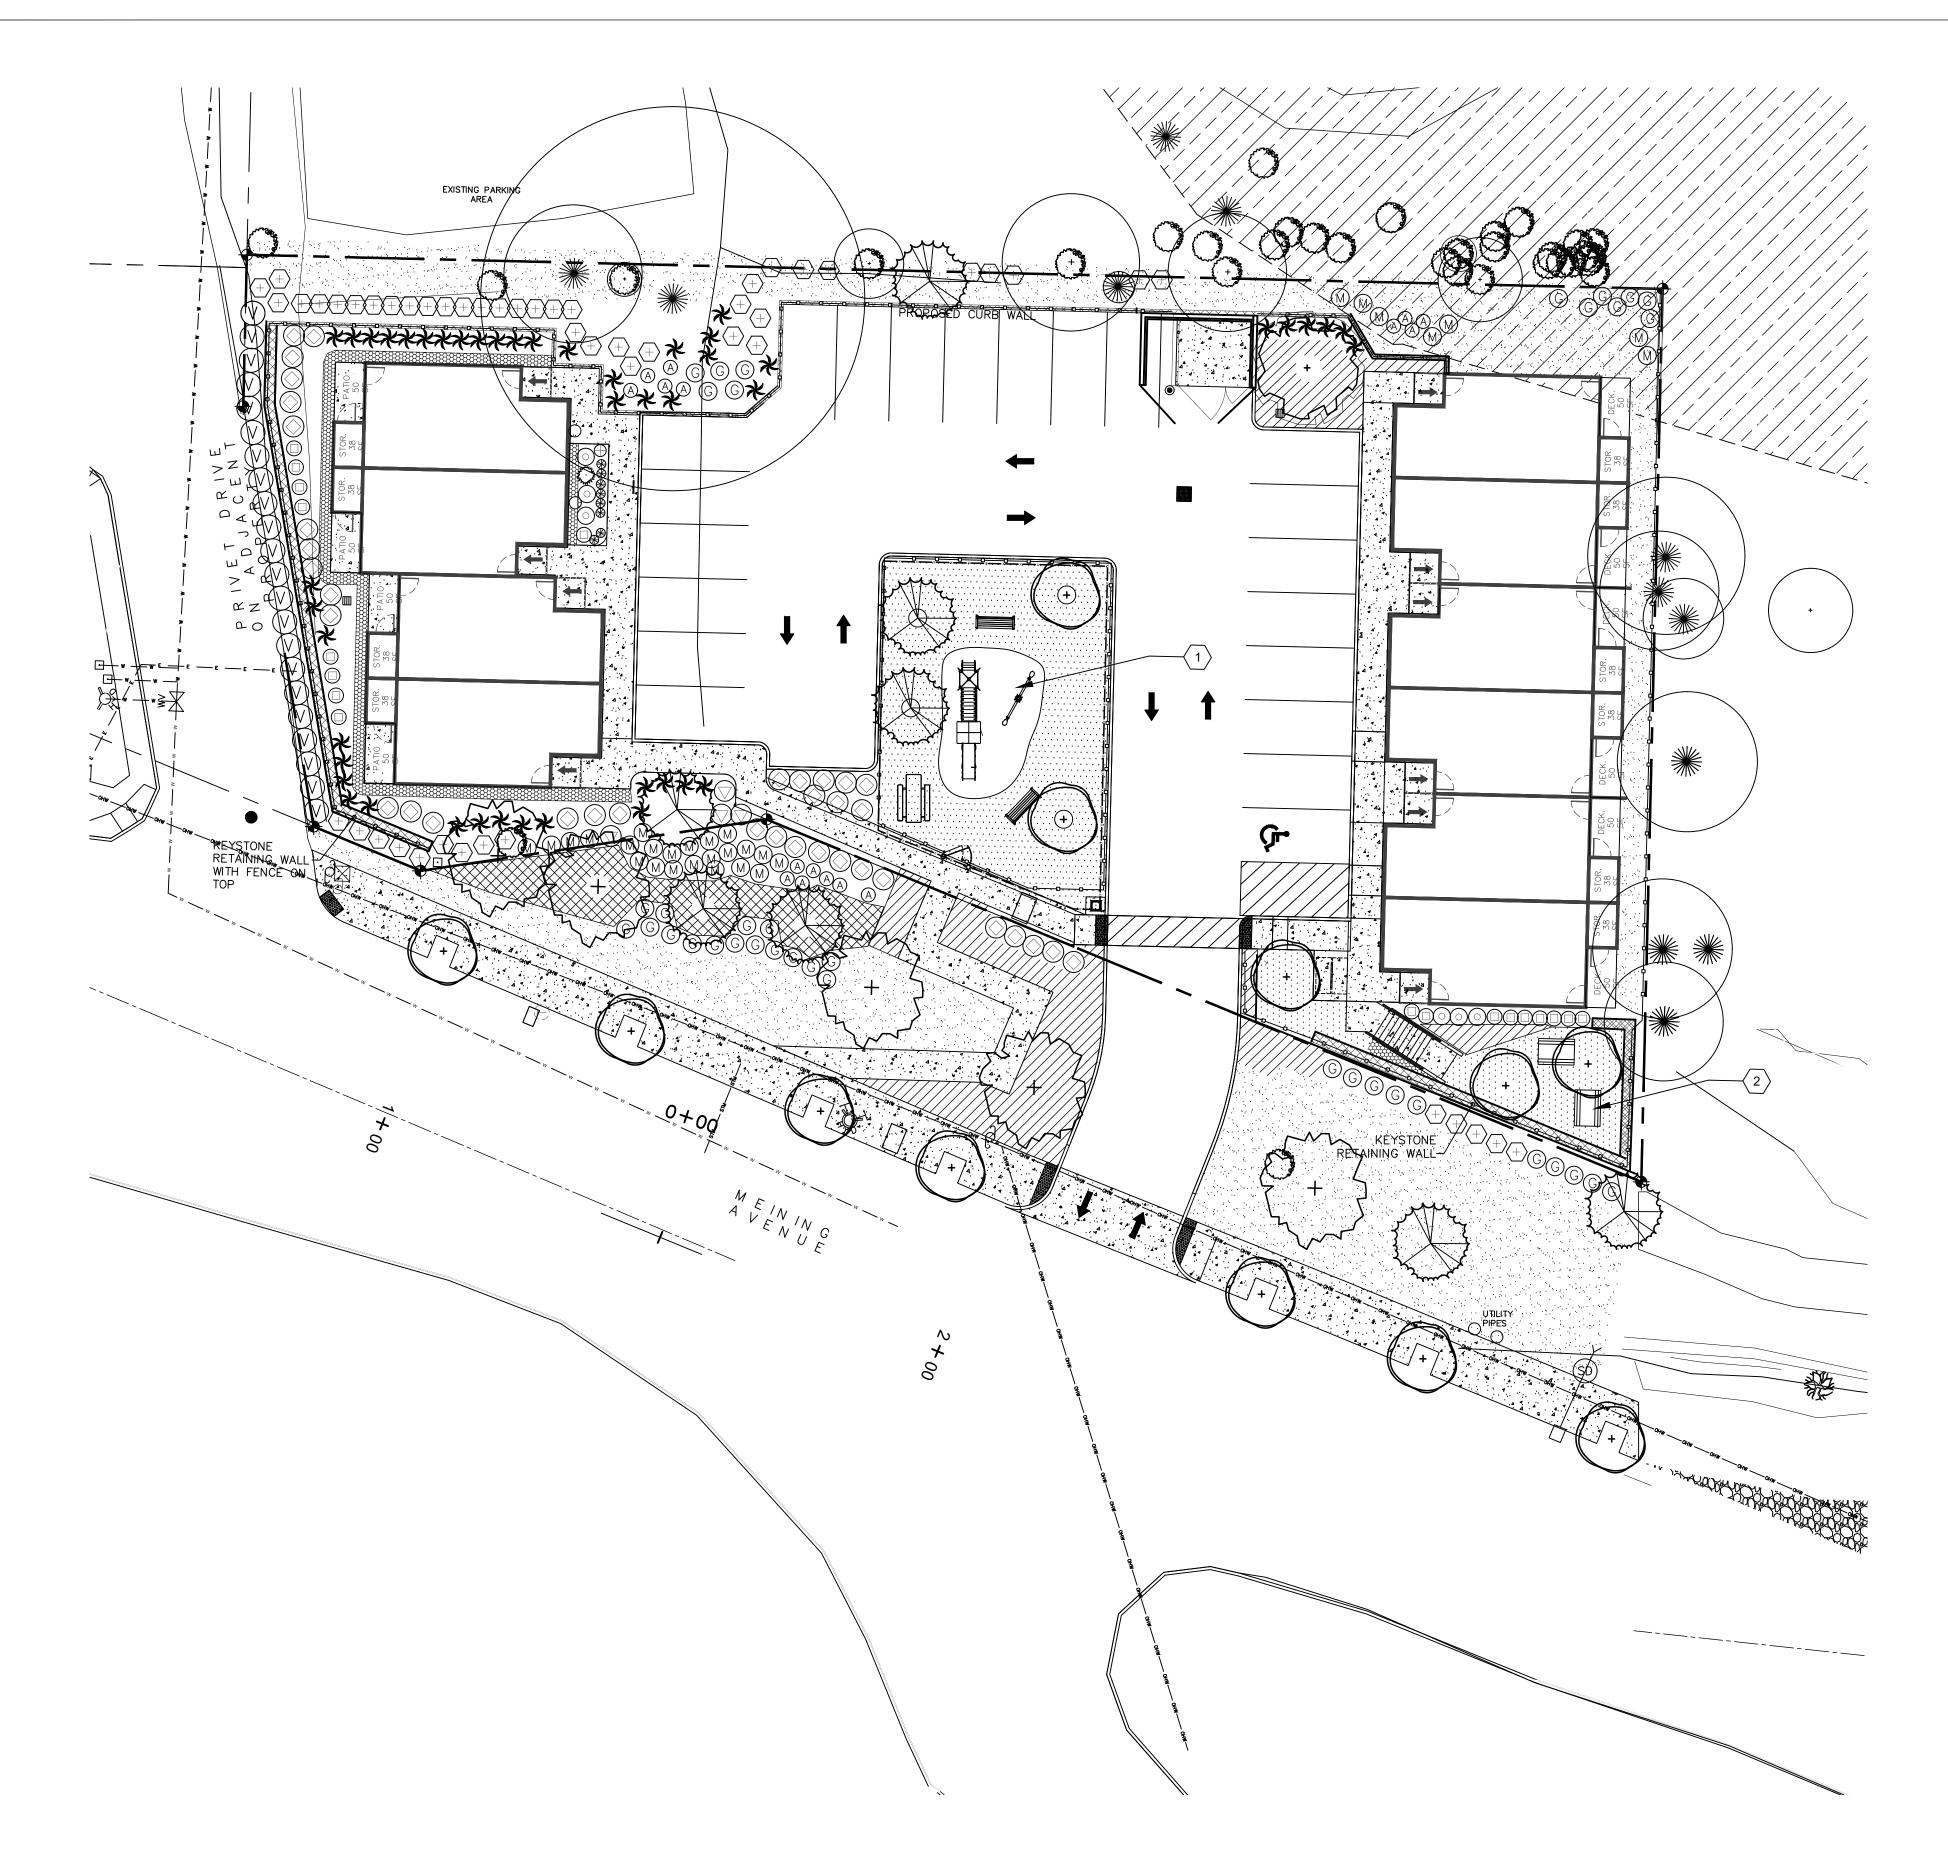

PLANT LIST

QUAN BOTANICAL NAME/COMMON NAME COMMENT

ACER BUERGERIANUM - TRIDENT MAPLE 1-1/2" CAL B&B AS SHOWN

CALOCEDRUS DECURRENS - INCENSE CEDAR REMOVE LOWEST BRANCHES

QUERCUS FRAINETTO 'FOREST GREEN' 2" CAL B&B AS SHOWN

FOREST GREEN OAK

RHAMNUS PURSHIANA 1-1/2" CAL B&B AS SHOWN

SHRUBS

SYM	QUAN	BOTANICAL NAME	COMMON NAME	SIZE	COMMENT
	18	EUONYMOUS FORTUNEI 'EMERALD GAIETY'	EMERALD GAIETY EUONYMOUS	2 GAL	SPACE AS SHOWN
\bigcirc	4	ILEX GLABRA 'SHAMROCK'	SHAMROCK INKBERRY	3 GAL	SPACE 42" O.C.
AN CALL	1	JUNIPERUS VIRGINIANA 'BLUE ARROW'	BLUE ARROW JUNIPER	48" HT.B&B	AS SHOWN
$\langle + \rangle$	51	MAHONIA AQUIFOLIUM	OREGON GRAPE	2 GAL	FULLY BRANCHED
\oplus	1	NANDINA DOMESTICA 'WOODS DWARF'	WOOD'S DWARF HEAVENLY BAMBO	O' 2 GAL	SPACE AS SHOWN
M	30	PHILADELPHUS LEWISII	MOCKORANGE	2 GAL	SPACE AS SHOWN
<u>(G</u>	38	ROSA GYMNOCARPA	BALDHIP ROSE	2 GAL	AS SHOWN
\triangle	20	SYMPHORICARPOS ALBUS	COMMON SNOWBERRY	2 GAL	AS SHOWN
\odot	6	SPIRAEA X BUMALDA 'GOLDMOUND'	GOLDMOUND BUMALD SPIREA	2 GAL	AS SHOWN
<u></u>	2	VIBURNUM DAVIDII	DAVID VIBURNUM	3 GAL	AS SHOWN
(\vee)	23	VIBURNUM TINUS	LAURUSTINUS	5 GAL	SPACE 48" O.C.
\bigcirc	37	VACCINIUM OVATUM	EVERGREEN HUCKLEBERRY	3 GAL	AS SHOWN

GROUNDCOVER

HELICHTOTRICHON SEMPERVIRENS - BLUE OAT GRASS

1 GAL - SPACE AS SHOWN

POLYSTICHUM MUNITUM - WESTERN SWORD FERN 1 GAL - SPACE AS SHOWN

ARCTOSTAPHYLOS UVA-URSI - KINNICKINICK 1 GAL - SPACE 2' O.C.

MAHONIA REPENS - CREPING MAHONIA

1 GAL - SPACE 30" O.C.

2340 SF PT 301- WATER SMARTER TALL FESCUE BLEND TURFWAY TALL FESCUE - FESTUCA ARUNDINACEA 'TURFWAY'

HOUNDOG 8 TALL FESCUE - FESTUCA ARUNDINACEA 'HOUNDOG 8' BLOODHOUND TALL FESCUE - FESTUCA ARUNDINACEA 'BLOODHOUND' 7 LBS / 1000 S.F.

4635 SF PT 702 - NATIVE URBAN MEADOW 4 OZ / 1000 S.F.

LEGEND

EXISTING TREE TO REMAIN

BENCH

GRAVEL EDGING -SEE SHEET L2 FOR DETAILS

KEY NOTES

RECREATIONAL PLAY AREA - SPECIFIC PLAY EQUIPMENT TO BE DETERMINED LATER

PICNIC AREA- PICNIC TABLES

GENERAL NOTES

1. ALL LANDSCAPE AREAS TO BE IRRIGATED WITH AN AUTOMATIC UNDERGROUND IRRIGATION SYSTEM. SYSTEM SHALL USE DRIP IRRIGATION AND WATER CONSERVATION ROTOR IRRIGATION HEADS. NATIVE PLANTING AREAS SHALL HAVE TEMPORARY IRRIGATION THAT WILL BE REDUCED EACH YEAR UNTIL PLANTS ARE FULLY ESTABLISHED.

2. QUANTITIES ARE INTENDED TO ASSIST THE CONTRACTOR IN EVALUATING THEIR OWN TAKEOFFS . THE CONTRACTOR SHALL BE RESPONSIBLE FOR BID QUANTITIES AS SHOWN AND REQUIRED BY THE PLANS.

3. CONTRACTOR SHALL PROVIDE TOPSOIL, SOIL AMENDMENTS, AND COMPOST IN REQUIRED QUANTITIES TO CREATE THE PLANTING SOIL FOR PLANTED AND

SEEDED AREAS IN ACCORDANCE WITH THE DETAILS AND SPECIFICATIONS. 4. CONTRACTOR SHALL VERIFY THE LOCATIONS OF UTILITIES PRIOR TO BEGINNING EXCAVATION.

5. IF PLANT MATERIAL CONFLICTS WITH NEW OR EXISTING UTILITIES TO REMAIN, THE CONTRACTOR SHALL ADJUST THE PLANTING LOCATIONS IN

COORDINATION WITH THE OWNER'S REPRESENTATIVE.

6. PROVIDE 3" OF BARK MULCH AROUND PLANTING.

7. RESTORE PUBLIC RIGHT IF AREA DISTURBED BY UTILITY INSTALLATION AND SEED AREA WITH NATIVE URBAN MEADOW MIX.

8. SEE SHEET L2 FOR PLANTING DETAILS AND NOTES.

SITE DATA

TOTAL SITE AREA = 25,869 S.F. REQUIRED LANDSCAPE AREA =

TOTAL LANDSCAPE AREA PROVIDED = RECREATION REQUIRED =

RECREATIONAL AREA PROVIDED

PICNIC AREA = 651.8 S.F. CHILDREN PLAY AREA = 2,054.1 S.F. TOTAL RECREATION AREA =

25% OF SITE AREA = 6,467.25 S.F.

32.98 % = 8,522.83 S.F. 2000 S.F.

2,705.9 S.F.

OREGON E

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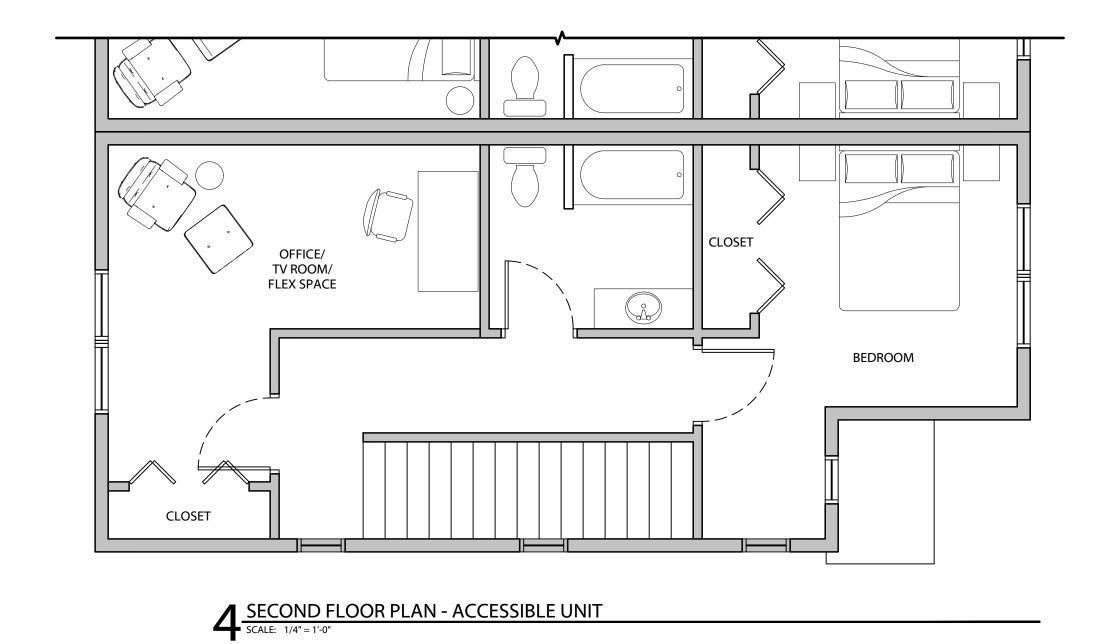



JOYCE JACKSON


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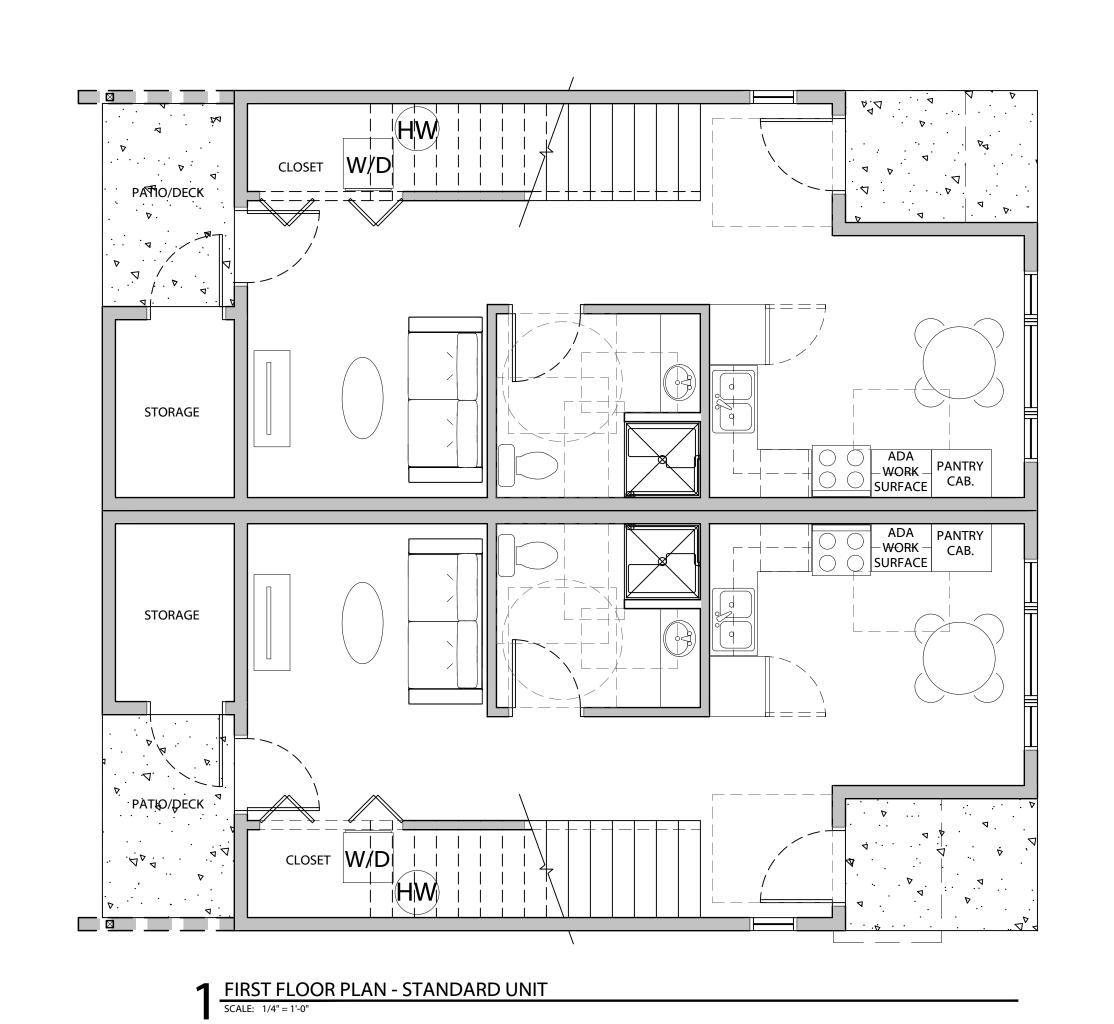
LANDSCAPE ARCHITECT 1940 SYLVAN WAY WEST LINN, OR 97068 503 703.8607 jj@joycejackson-la.com

REVISIONS No. Description Date DRAWN BY: JJ CHECKED JOB NO:20-004 DATE: **07/7/2021** DESIGN REVIEW PLANTING PLAN





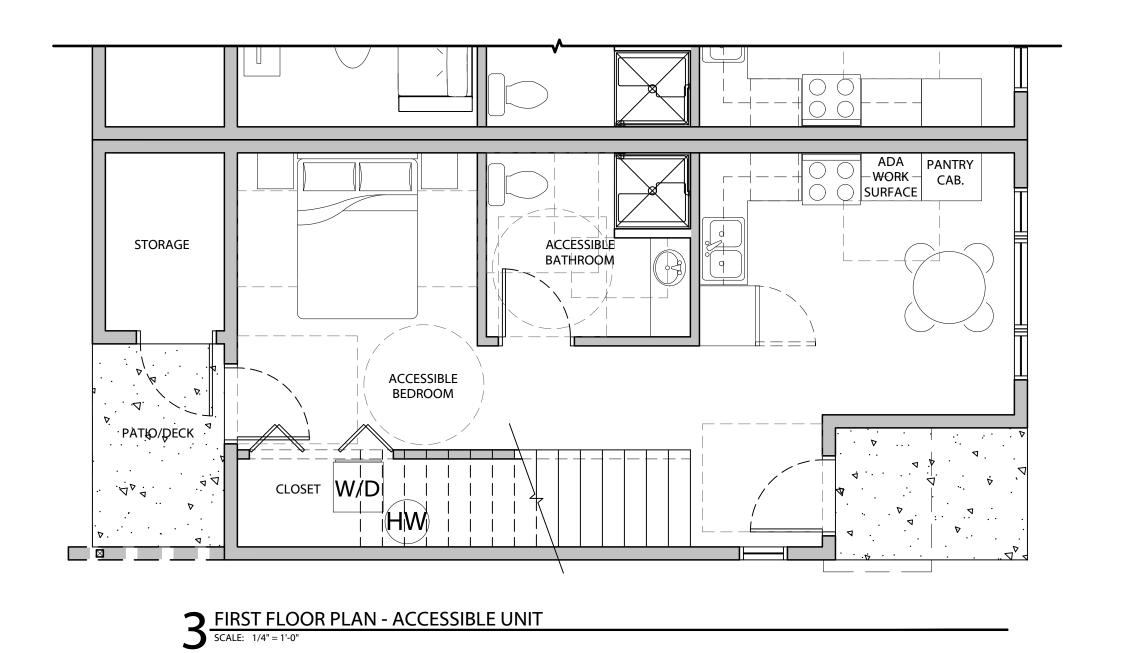

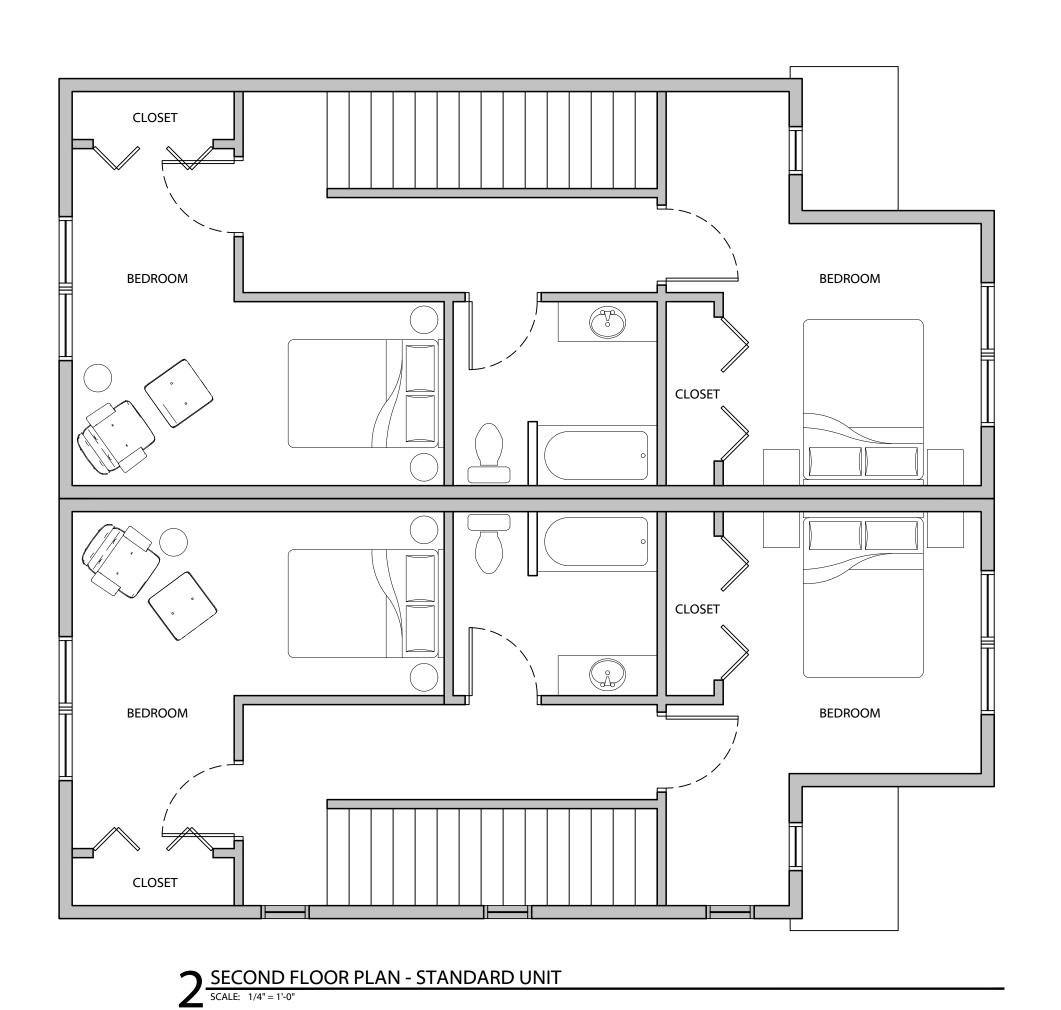

THE TOWNHOME

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No.	Description

CHECKED BY: DH
JOB NO: 20-004

DATE: 07/16/2021


ISSUED FOR: DESIGN REVIEW

SHEET TITLE

FIRST AND SECOND FLOOR PLANS
PROPOSED

SHEET NO.

A-201

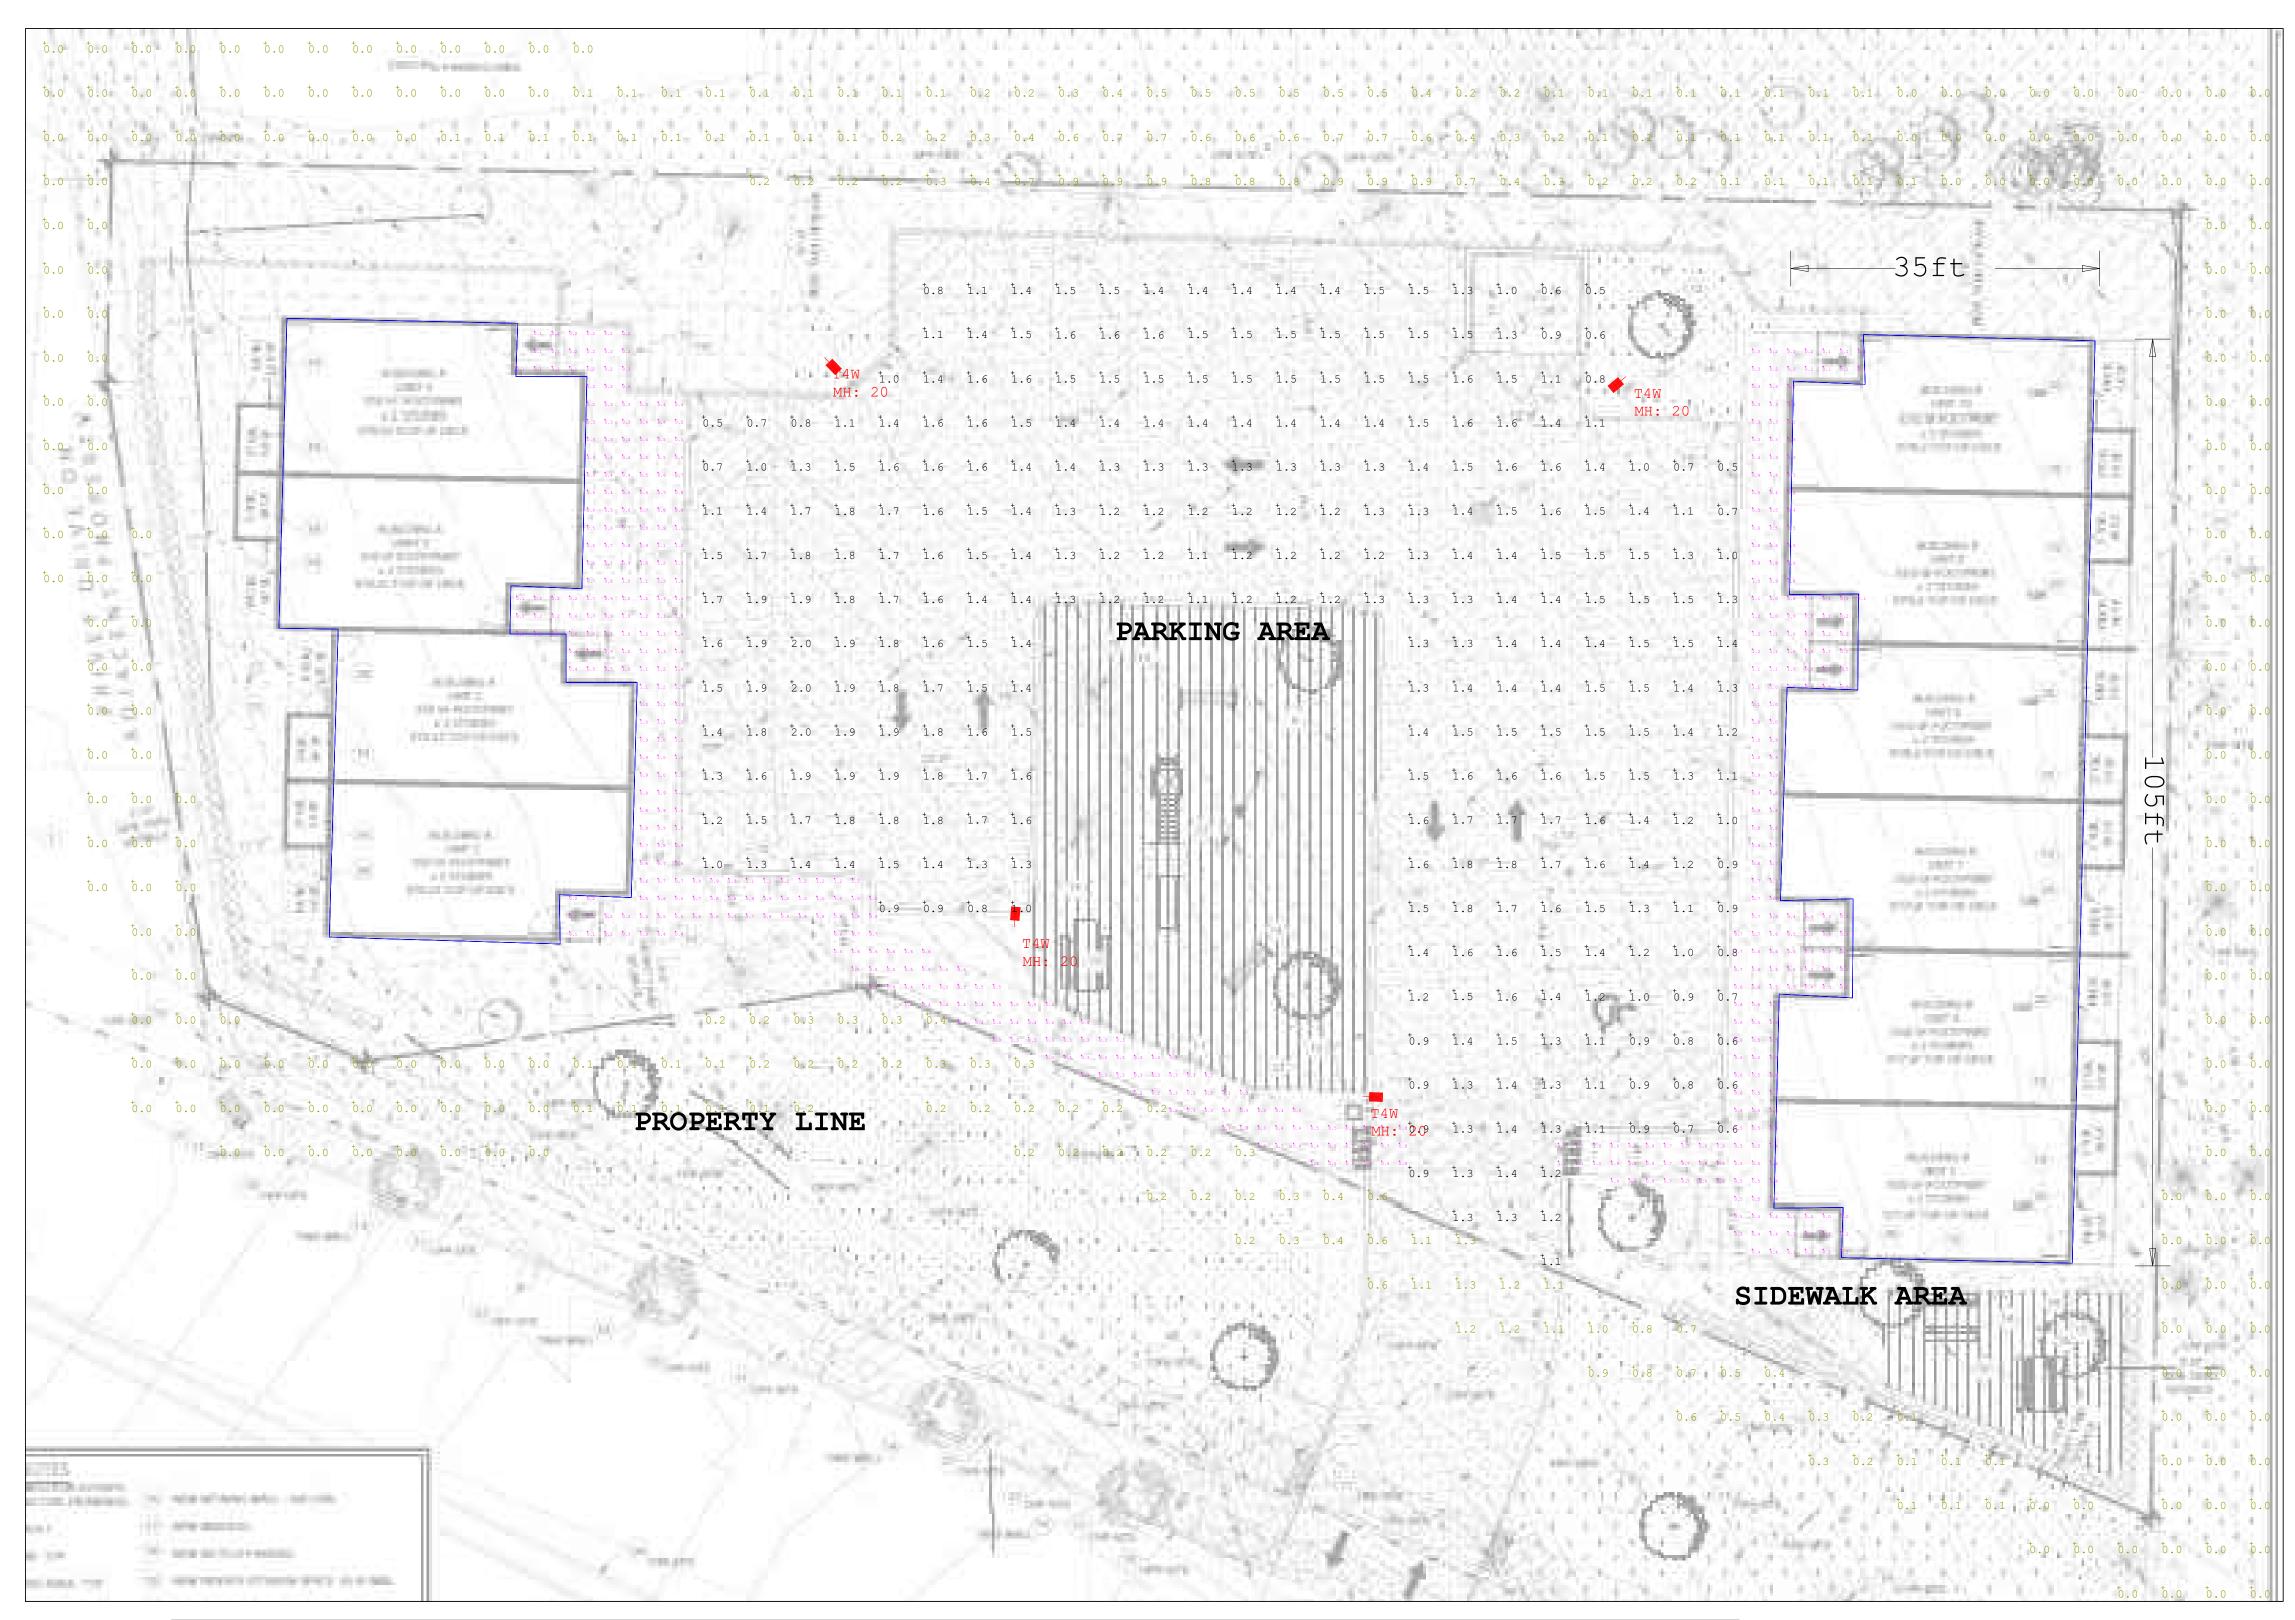

Luminaire Schedule							
Symbol	Label	Qty	Lum. Watts	Lum. Lumens	LLF	Arrangement	Description
	T4W	4	49.8	6245	0.850	SINGLE	RAR1-80L-50-4K7-4W


Calculation Summary							
Label	CalcType	Units	Avg	Max	Min	Avg/Min	Max/Min
Parking area	Illuminance	Fc	1.37	2.0	0.5	2.74	4.00
Property line	Illuminance	Fc	0.16	1.3	0.0	N.A.	N.A.
Sidewalk area	Illuminance	Fc	0.58	1.5	0.0	N.A.	N.A.

Note:

Calculation Grid (5ft x 5ft) @ Ground Level.

SidewalkGrid (2ft x 2ft) @ Ground Level.

Luminaire mounting heights are noted on each Luminaire Label.

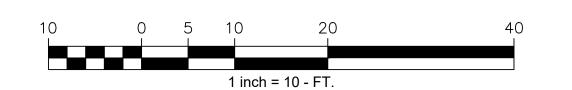

LT-1

THIS LIGHTING DESIGN IS BASED ON LIMITED INFORMATION SUPPLIED BY OTHERS TO HUBBELL LIGHTING. SITE DETAILS PROVIDED HEREON ARE REPRODUCED ONLY AS A VISUALIZATION AID. FIELD DEVIATIONS MAY SIGNIFICANTLY AFFECT PREDICTED PERFORMANCE. PRIOR TO INSTALLATION RITICAL SITE INFORMATION (POLE LOCATIONS, ORIENTATION, MOUNTING HEIGHT, ETC.) SHOULD BE COORDINATED WITH THE CONTRACTOR AND/OR SPECIFIER RESPONSIBLE FOR THE PROJECT.

LUMINAIRE DATA IS TESTED TO INDUSTRY STANDARDS UNDER LABORATORY CONDITIONS. OPERATING VOLTAGE AND NORMAL MANUFACTURING TOLERANCES OF LAMP, BALLAST, AND LUMINAIRE MAY AFFECT FIELD RESULTS.

PHOTOMETRIC PLAN
The Pad Townhouses Sandy OR

REVISED FROM DRAWING NUMBER(S):	®	DN BY:	DATE:
-26577	HUBBELL	Harish	05-27-
-26577R1	HUBBELL	REV. BY:	DATE:
	Hubbell Lighting, Inc. 701 MILLENNIUM BLVD.	QUOTE:	DRAWING /
	GREENVILLE, SC 29607	l N/A	\mathbf{Q}