

SANDY COMMUNITY CAMPUS PARK -

PROJECT TEAM

CLIENT


City of Sandy Parks & Recreation 38348 Pioneer Boulevard Sandy, OR 97055

LANDSCAPE ARCHITECT

Lango Hansen Landscape Architects 1100 NW Glisan #3A Portland, OR 97209 Contact: Brian Martin Email: brian@langohansen.com Phone: 503.295.2437


CIVIL ENGINEER


Humber Design Group, Inc. 110 SE Main Street Suite 200 Portland, OR 97214 Contact: Allen Schmitz Email: allen.schmitz@hdgpdx.com Phone: 503.488.5711

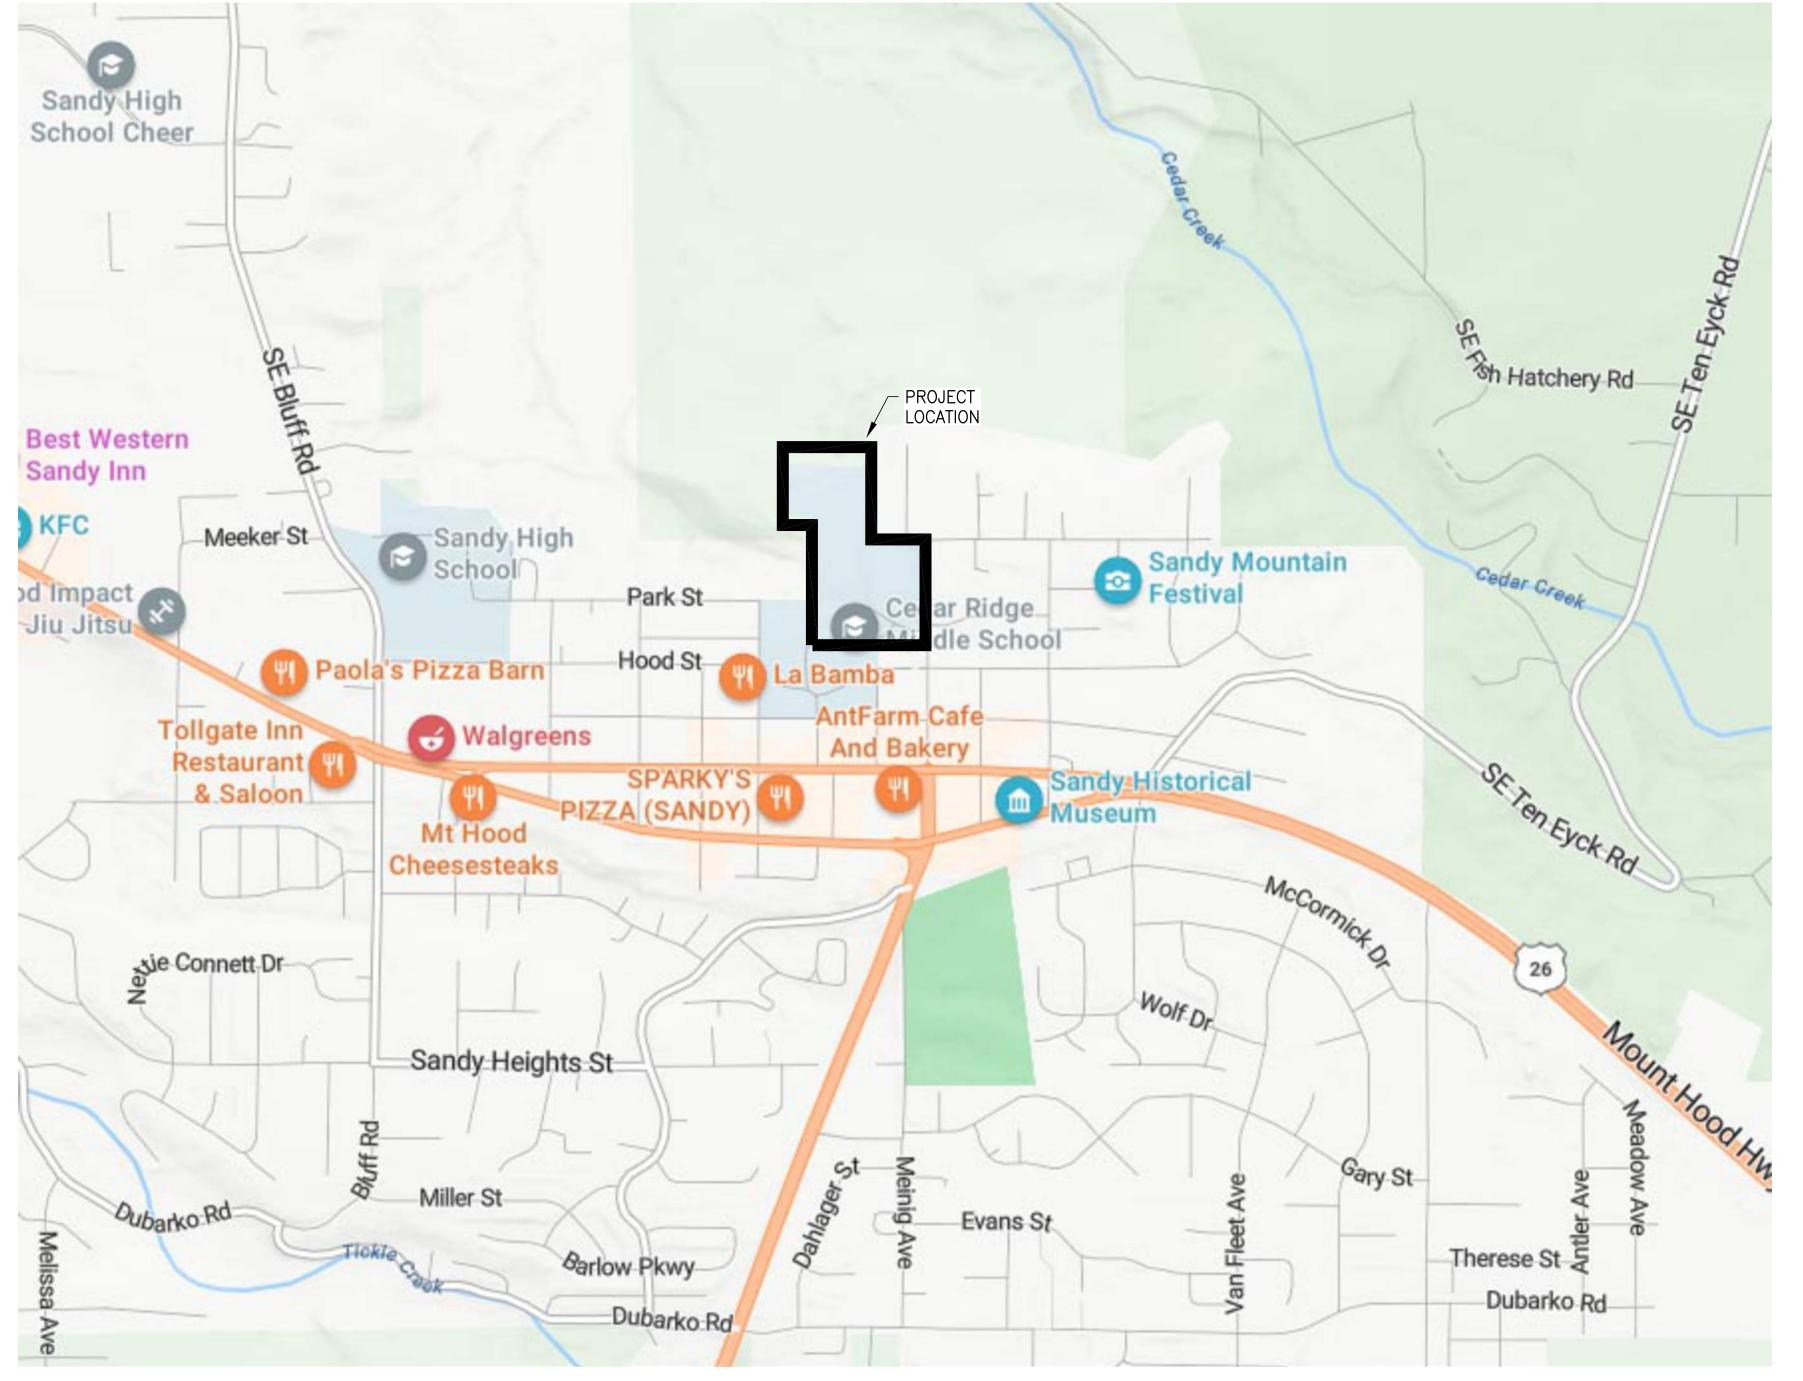

VICINITY MAP

PARK ADDRESS: 17165 SE MEINIG AVE, SANDY, OR 97055

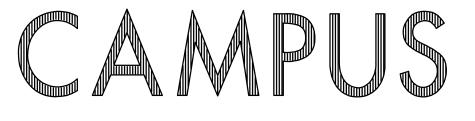

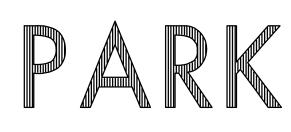

ELECTRICAL ENGINEER

R&W Electrical Engineering 9615 SW Allen Blvd #107, Beaverton, OR 97005 Contact: Jonathan Lilly Email: jlilly@rweng.com Phone: 503.726.3337

UTILITY CONTACTS



ND USE SUBMITTAL EXHIBITD

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SCALE DRAWN BY DATE PROJECT NO. COVER SHEET

AS NOTED BDM 06.21.23 2239

revisions

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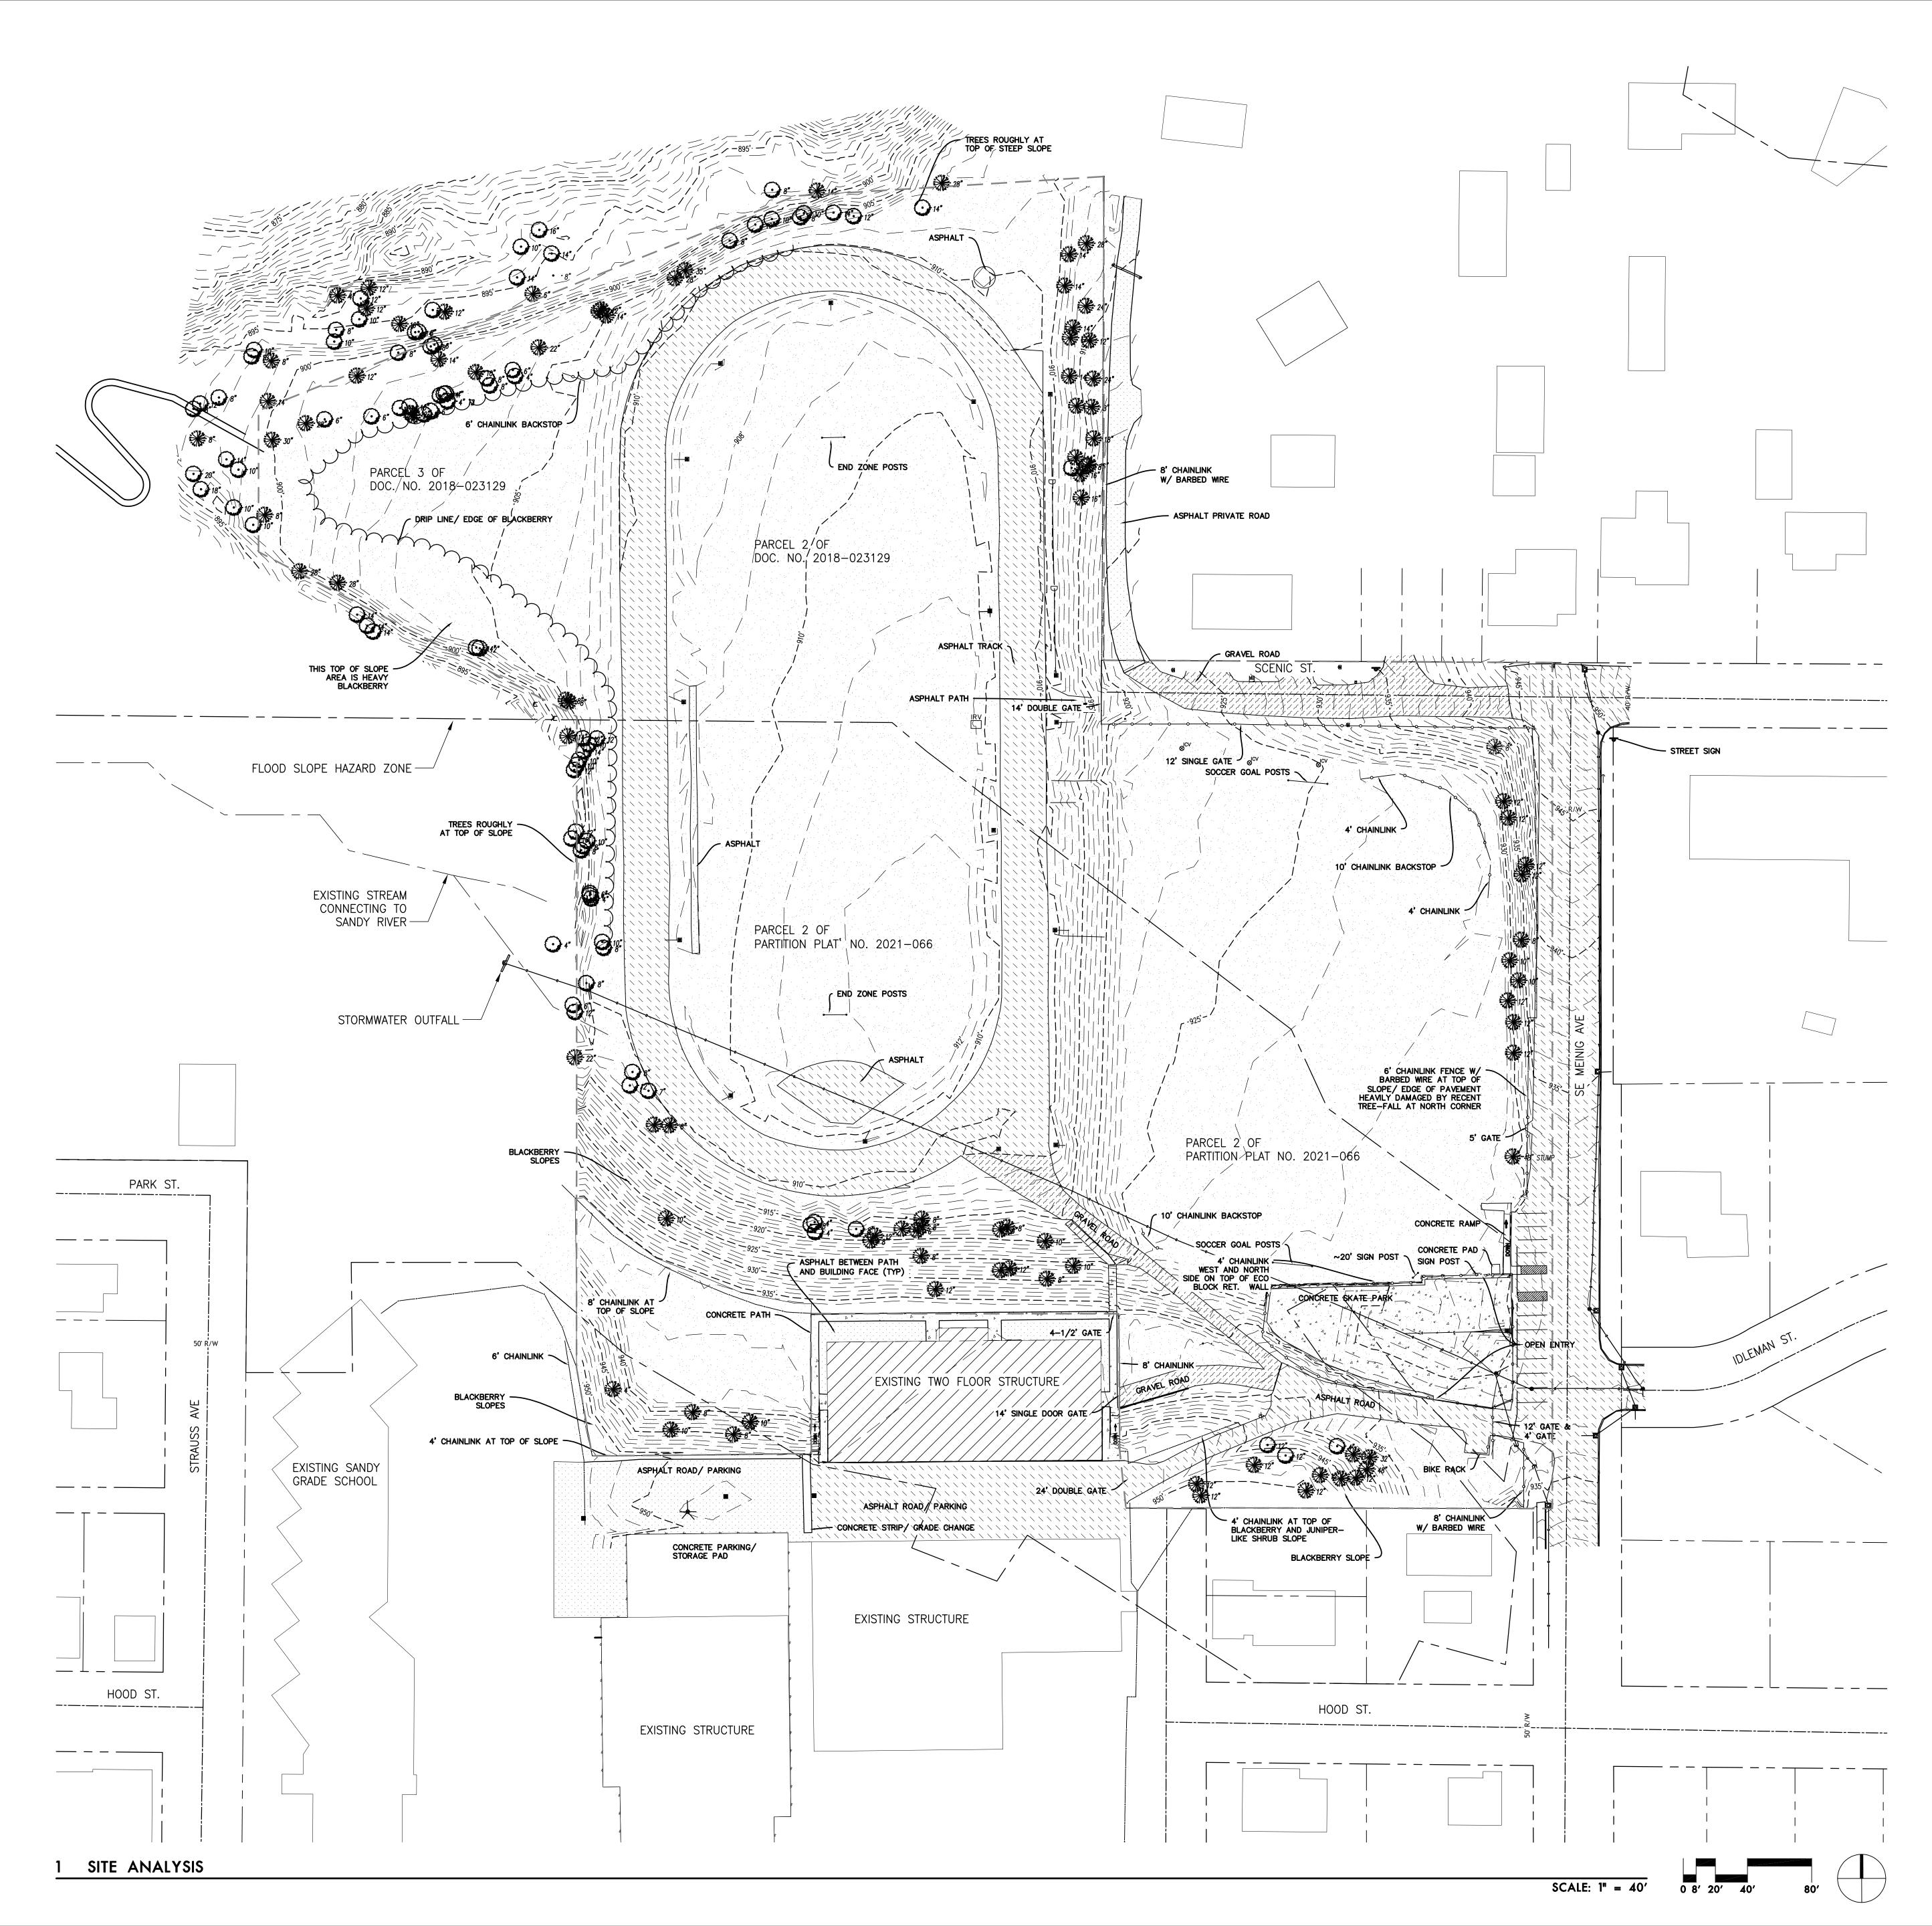
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SITE SURVEY LEGEND

— — — — — LIMIT OF WORK
CHAINLINK FENCE
EDGE OF BRUSH
— — — 900' — — — MAJOR CONTOUR (5')
— — — — — MINOR CONTOUR (1')
ASPHALT
GRAVEL
GRASS
🗱 EXISTING CONIFEROUS TREE
EXISTING DECIDUOUS TREE



SCALE DRAWN BY DATE PROJECT NO. 2239 SITE ANALYSIS

as noted BDM 06.21.23

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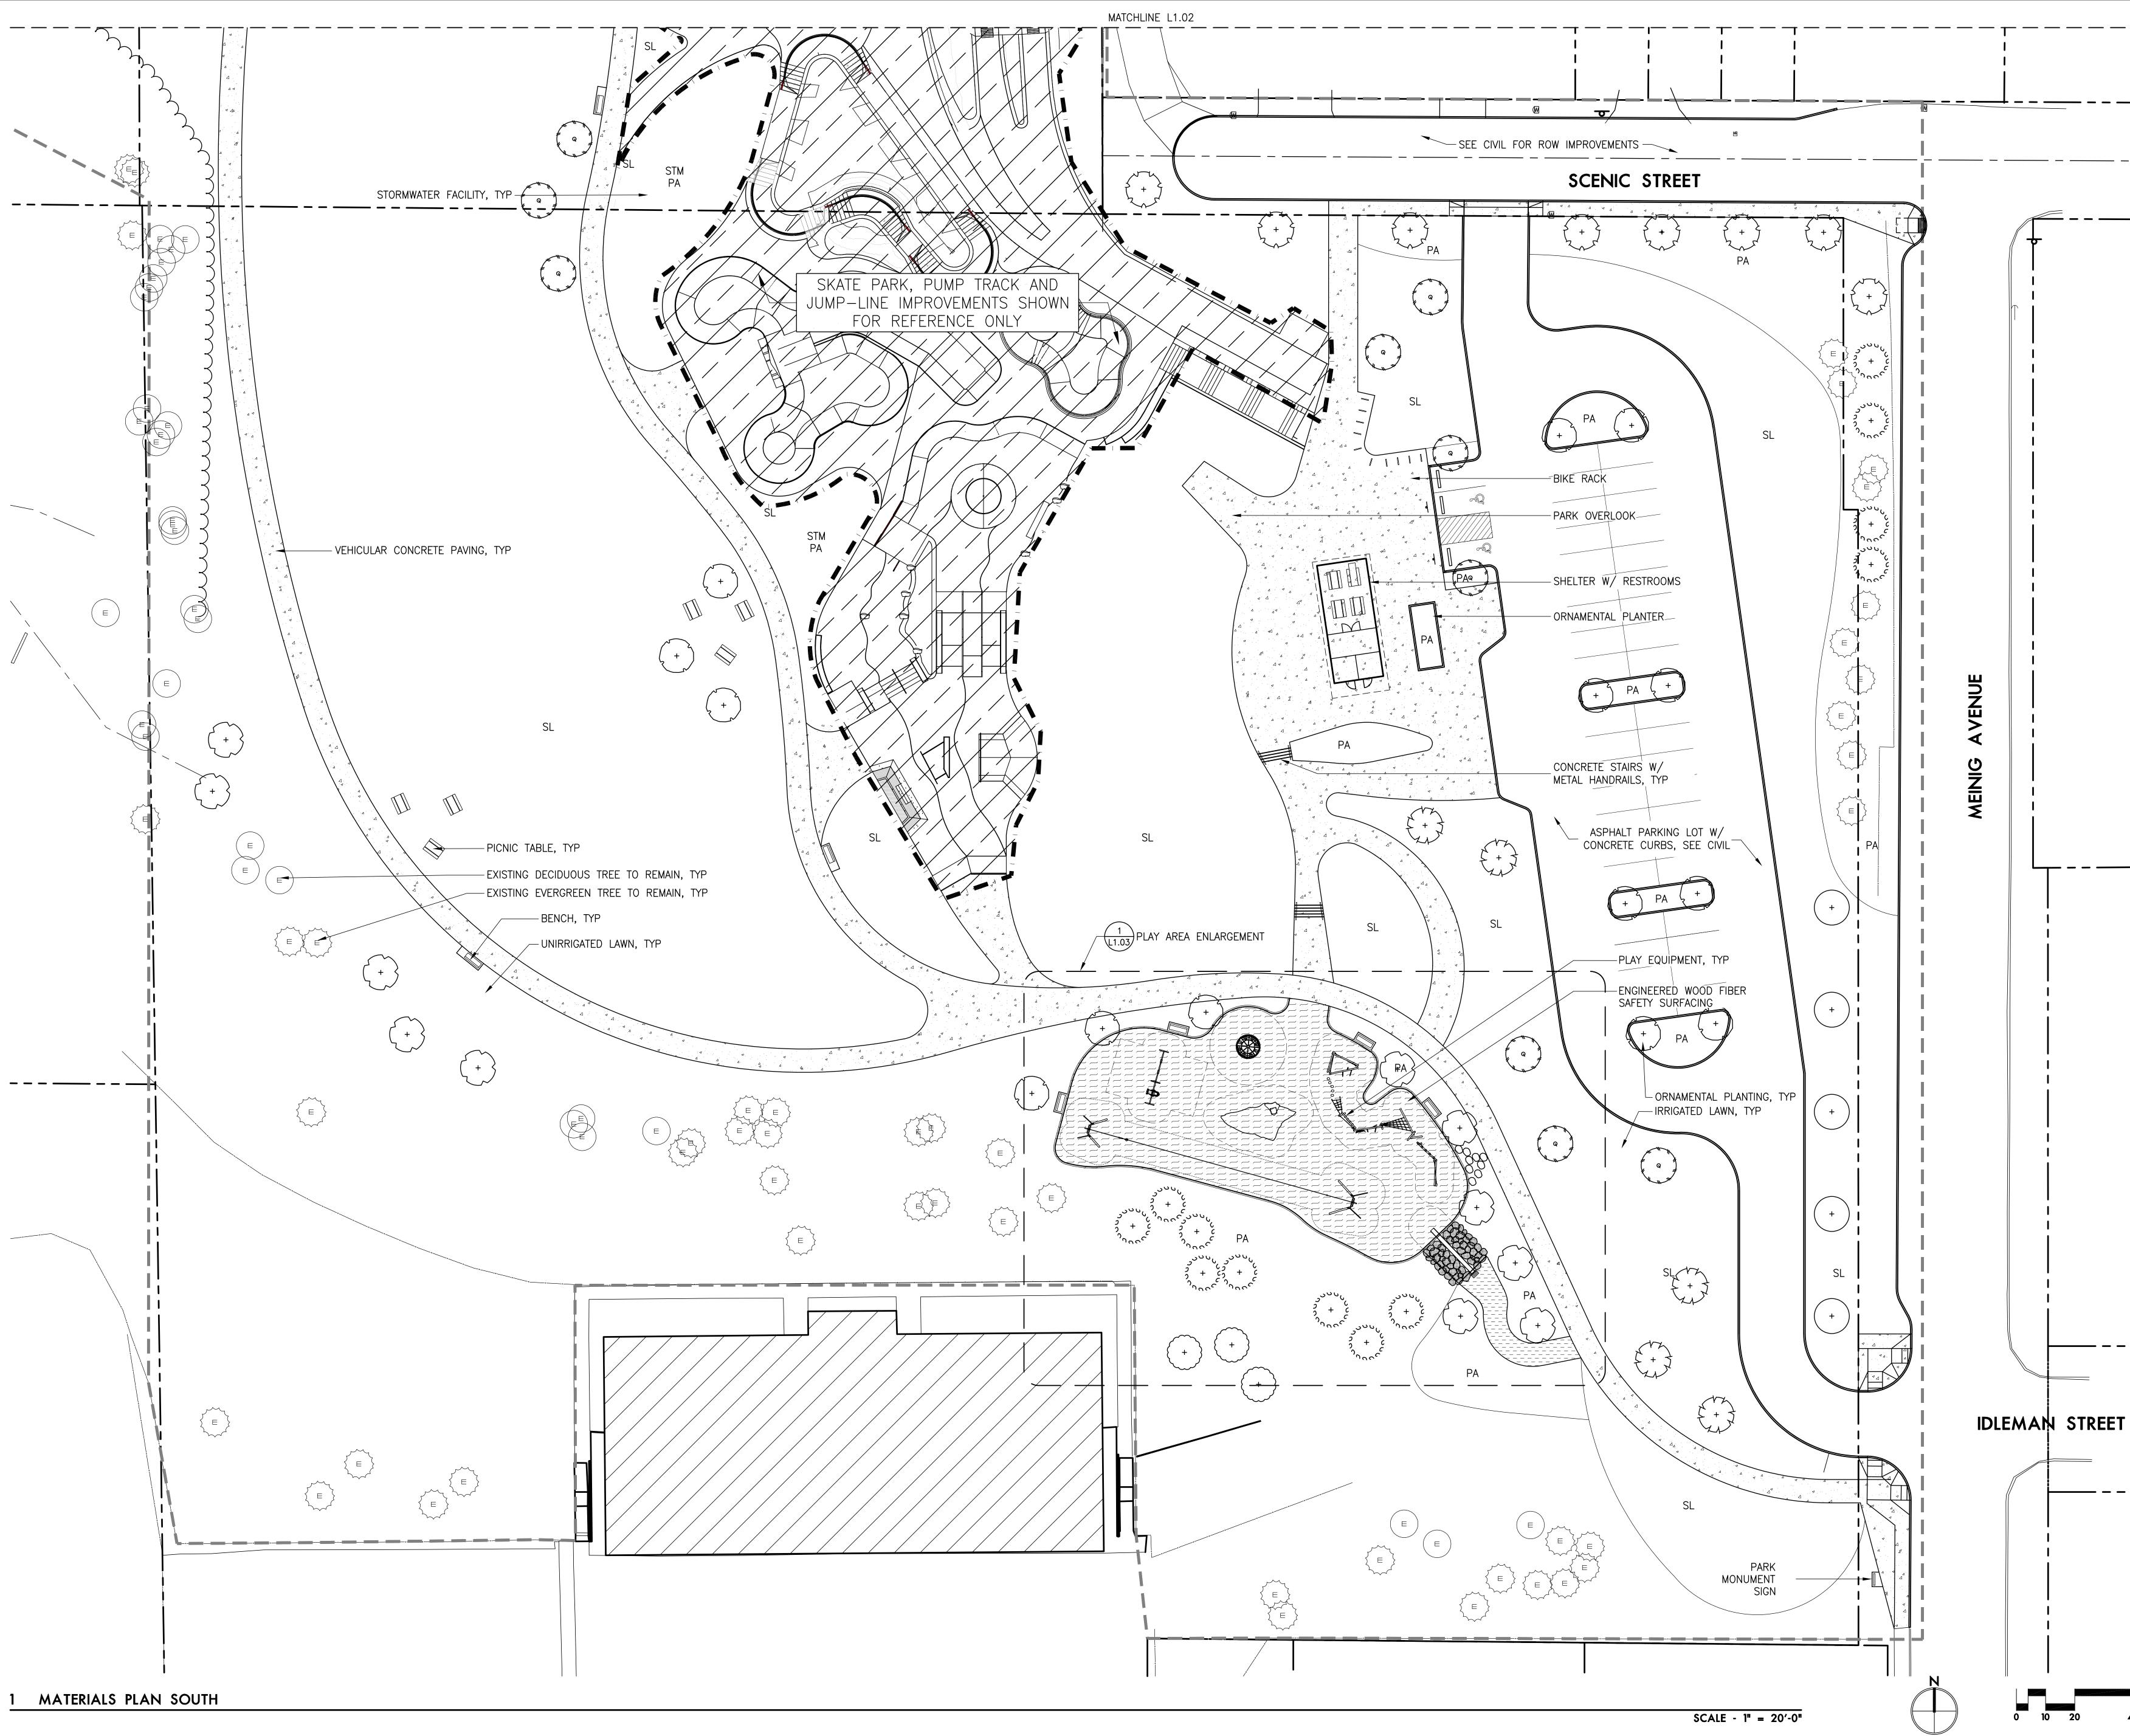
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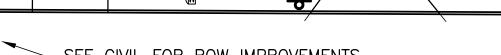
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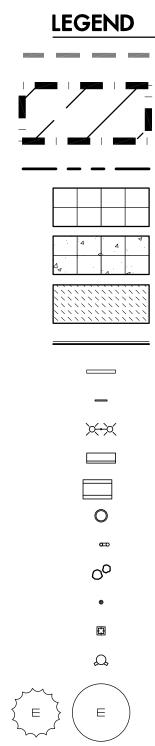
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- - - LIMIT OF WORK - PARK IMPROVEMENTS

LIMIT OF WORK - SKATE PARK, PUMP TRACK, JUMP-LINE

PEDESTRIAN CONCRETE PAVING

VEHICULAR CONCRETE PAVING

SOFT SURFACE PATH

$\langle \rangle$	
	CONCRETE CURB
	CONCRETE WHEELSTOP
	BIKE RACK
	SITE LIGHT, SEE ELEC DWG
	BENCH WITH BACK
	PICNIC TABLE
	TRASH RECEPTACLE
	DRINKING FOUNTAIN
	BOULDERS
	BOLLARD
	AREA DRAIN, SEE CIVIL UTILITY DWG
	FIRE HYDRANT, SEE CIVIL UTILITY DWG
	EXISTING TREE TO REMAIN



ABBREVIATIONS

ARCH ARCHITECTURAL CONC DWG CONCRETE DRAWINGS ELEC ELECTRICAL MECH MECHANICAL NIC NOT IN CONTRACT PA PLANTING AREA SIM SIMILAR SPECS SPECIFICATIONS STRUC TYP STRUCTURAL TYPICAL W/ WITH

MATERIALS NOTES

- 1. THIS PLAN IS BASED ON A SURVEY BY 45TH PARALLEL GEOMATICS DATED 02/09/2023. NOTIFY OWNER'S REPRESENTATIVE OF ANY DISCREPANCIES IDENTIFIED ON SITE RELATED TO SURVEY INFORMATION PRIOR TO INSTALLATION.
- 2. PROTECT EXISTING VEGETATION TO REMAIN. SEE SPECIFICATION SECTION 015639 FOR FENCING AND OTHER REQUIREMENTS.
- 3. SEE CIVIL DRAWINGS FOR LOCATION OF UTILITIES. 4. SEE ELECTRICAL DRAWINGS FOR FURTHER
- INFORMATION REGARDING SITE LIGHTING AND ELECTRIC UTILITIES.
- 5. SEE SHEET ____ FOR LOCATIONS OF IRRIGATION SLEEVES UNDER PAVING.
- 6. COORDINATE WORK WITH OTHER TRADES, INCLUDING WORK IN OTHER BID PACKAGES.
- 7. ALL CONCRETE PAVING TO RECEIVE LIGHT BROOM FINISH UNLESS OTHERWISE NOTED. SEE DETAILS FOR CIP CONCRETE RETAINING WALL AND CHEEK WALL FINISHES. CONTRACTOR TO PROVIDE FINISH MOCKUPS FOR APPROVAL, SEE SPECIFICATIONS.
- 8. CONTRACTOR TO SUBMIT PAVING MOCK-UP FOR APPROVAL BY OWNER'S REPRESENTATIVE PRIOR TO INSTALLATION.
- 9. SEE CIVIL DRAWINGS FOR ALL VEHICULAR AREA IMPROVEMENTS, INCLUDING PAVING, CURBS, DRIVEWAY APRONS, STRIPING AND SIGNAGE, AS WELL AS ANY VEHICULAR AND PEDESTRIAN PAVING IMPROVEMENTS WITHIN THE RIGHT-OF-WAY.



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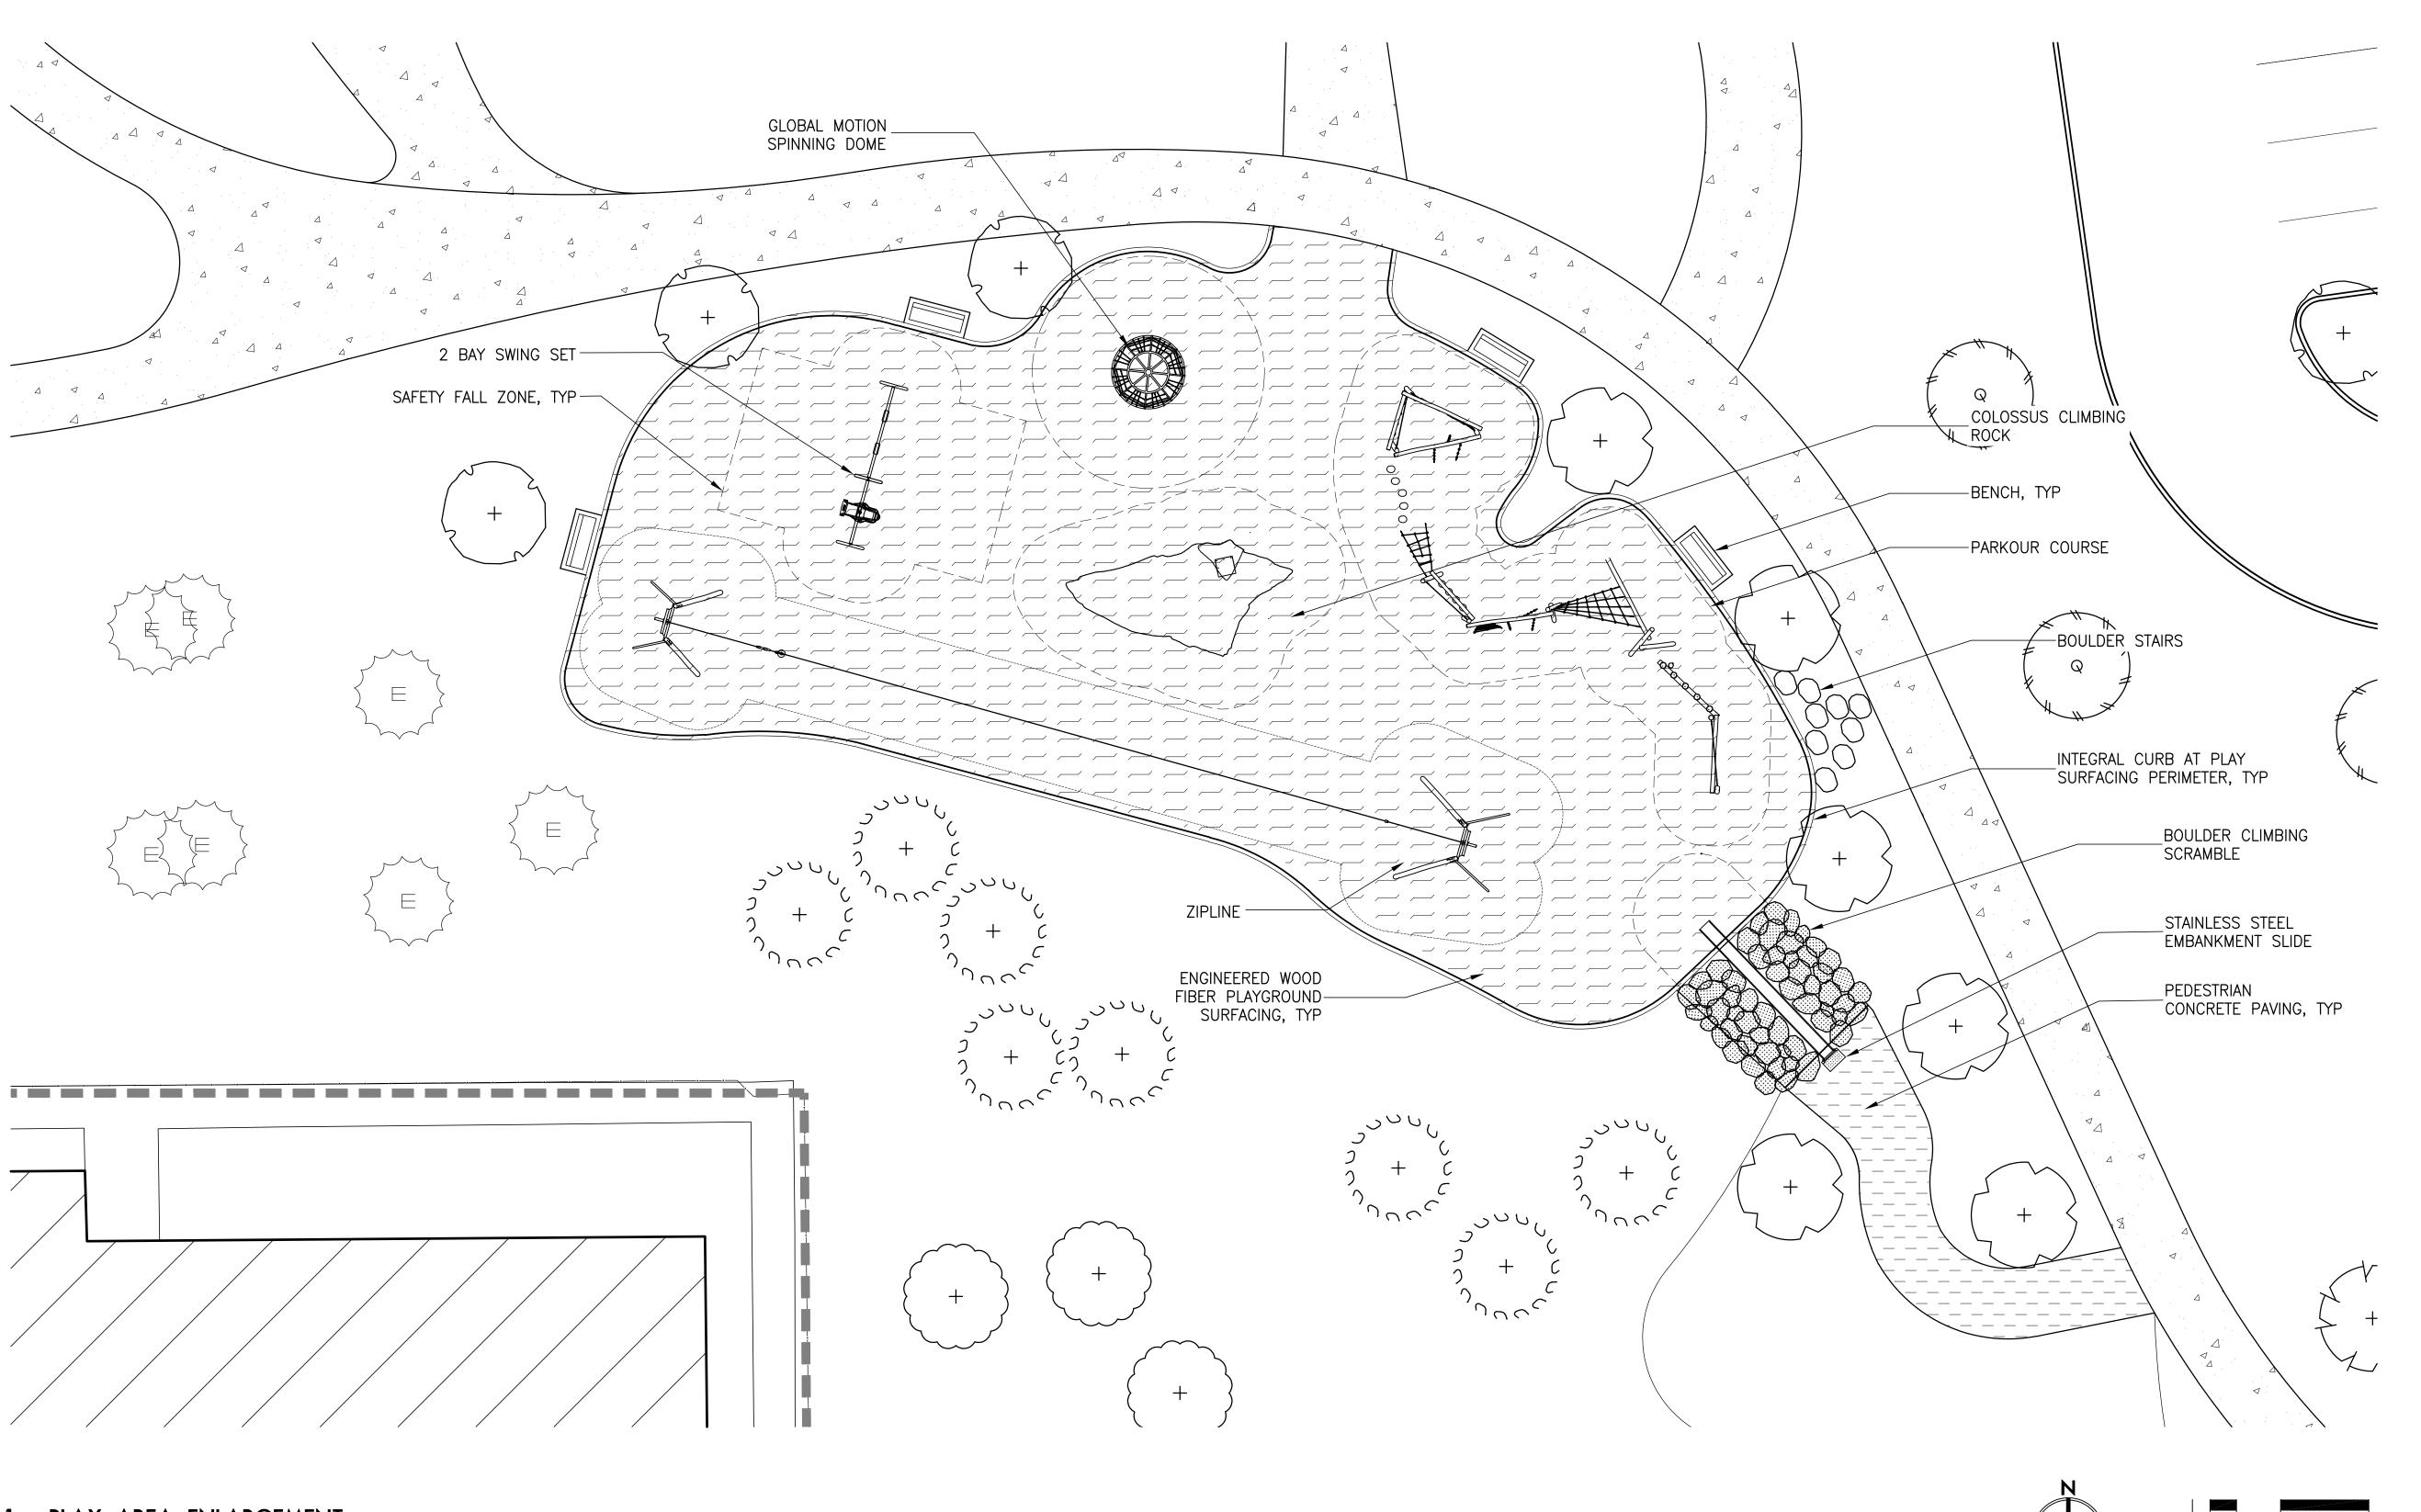



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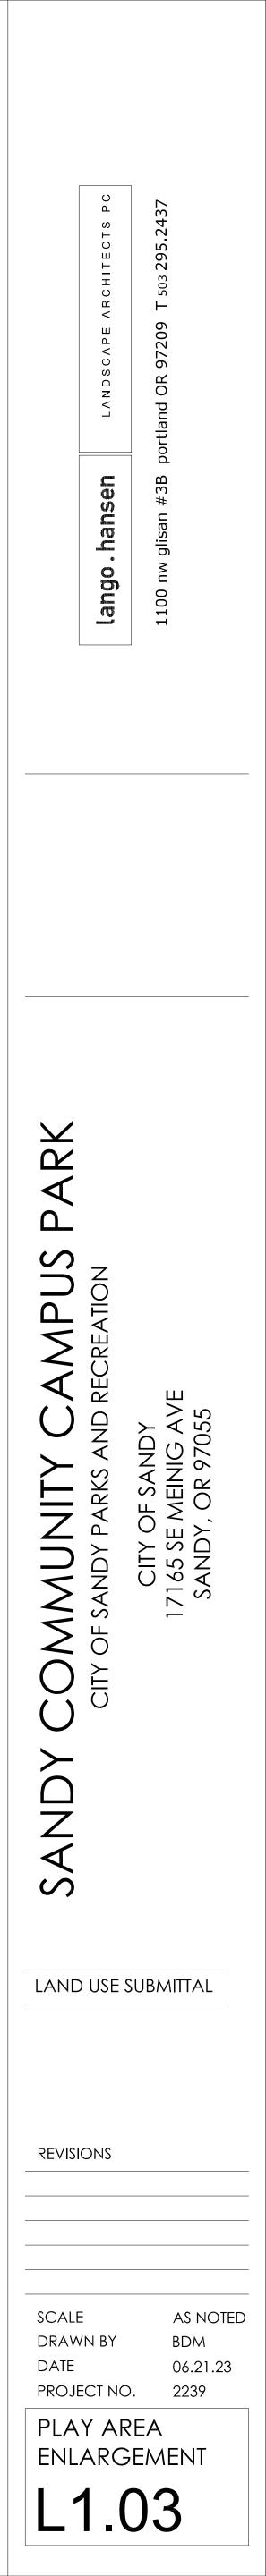
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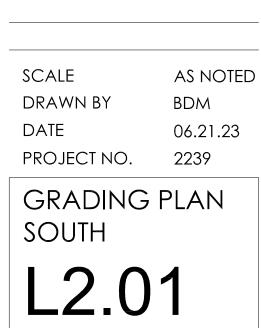




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LEGEND - - - LIMIT OF WORK - PARK IMPROVEMENTS AREA DRAIN (RIM ELEVATION) AD BC BOTTOM OF CURB LIMIT OF WORK – SKATE PARK, ΒF BOTTOM OF FOOTING PUMP TRACK, JUMP-LINE BOTTOM OF WALL (FINISHED GRADE) BW CB CATCH BASIN (RIM ELEVATION) CTV CONTRACTOR TO VERIFY ELEVATION EL EQUAL EQ EXISTING ΕX BOTTOM OF SWALE LINE FINISH FLOOR ELEVATION FFE ----- GRADE BREAK LINE FINISH SURFACE FS HIGH POINT ΗP SPOT ELEVATION 485.00 INVERT ELEVATION LP LOW POINT 4.8% MATCH EXISTING GRADE MATCH -DIRECTION OF SLOPE MAXIMUM MAX MINIMUM MIN RIM RIM ELEVATION SIM SIMILAR

ABBREVIATIONS

TC

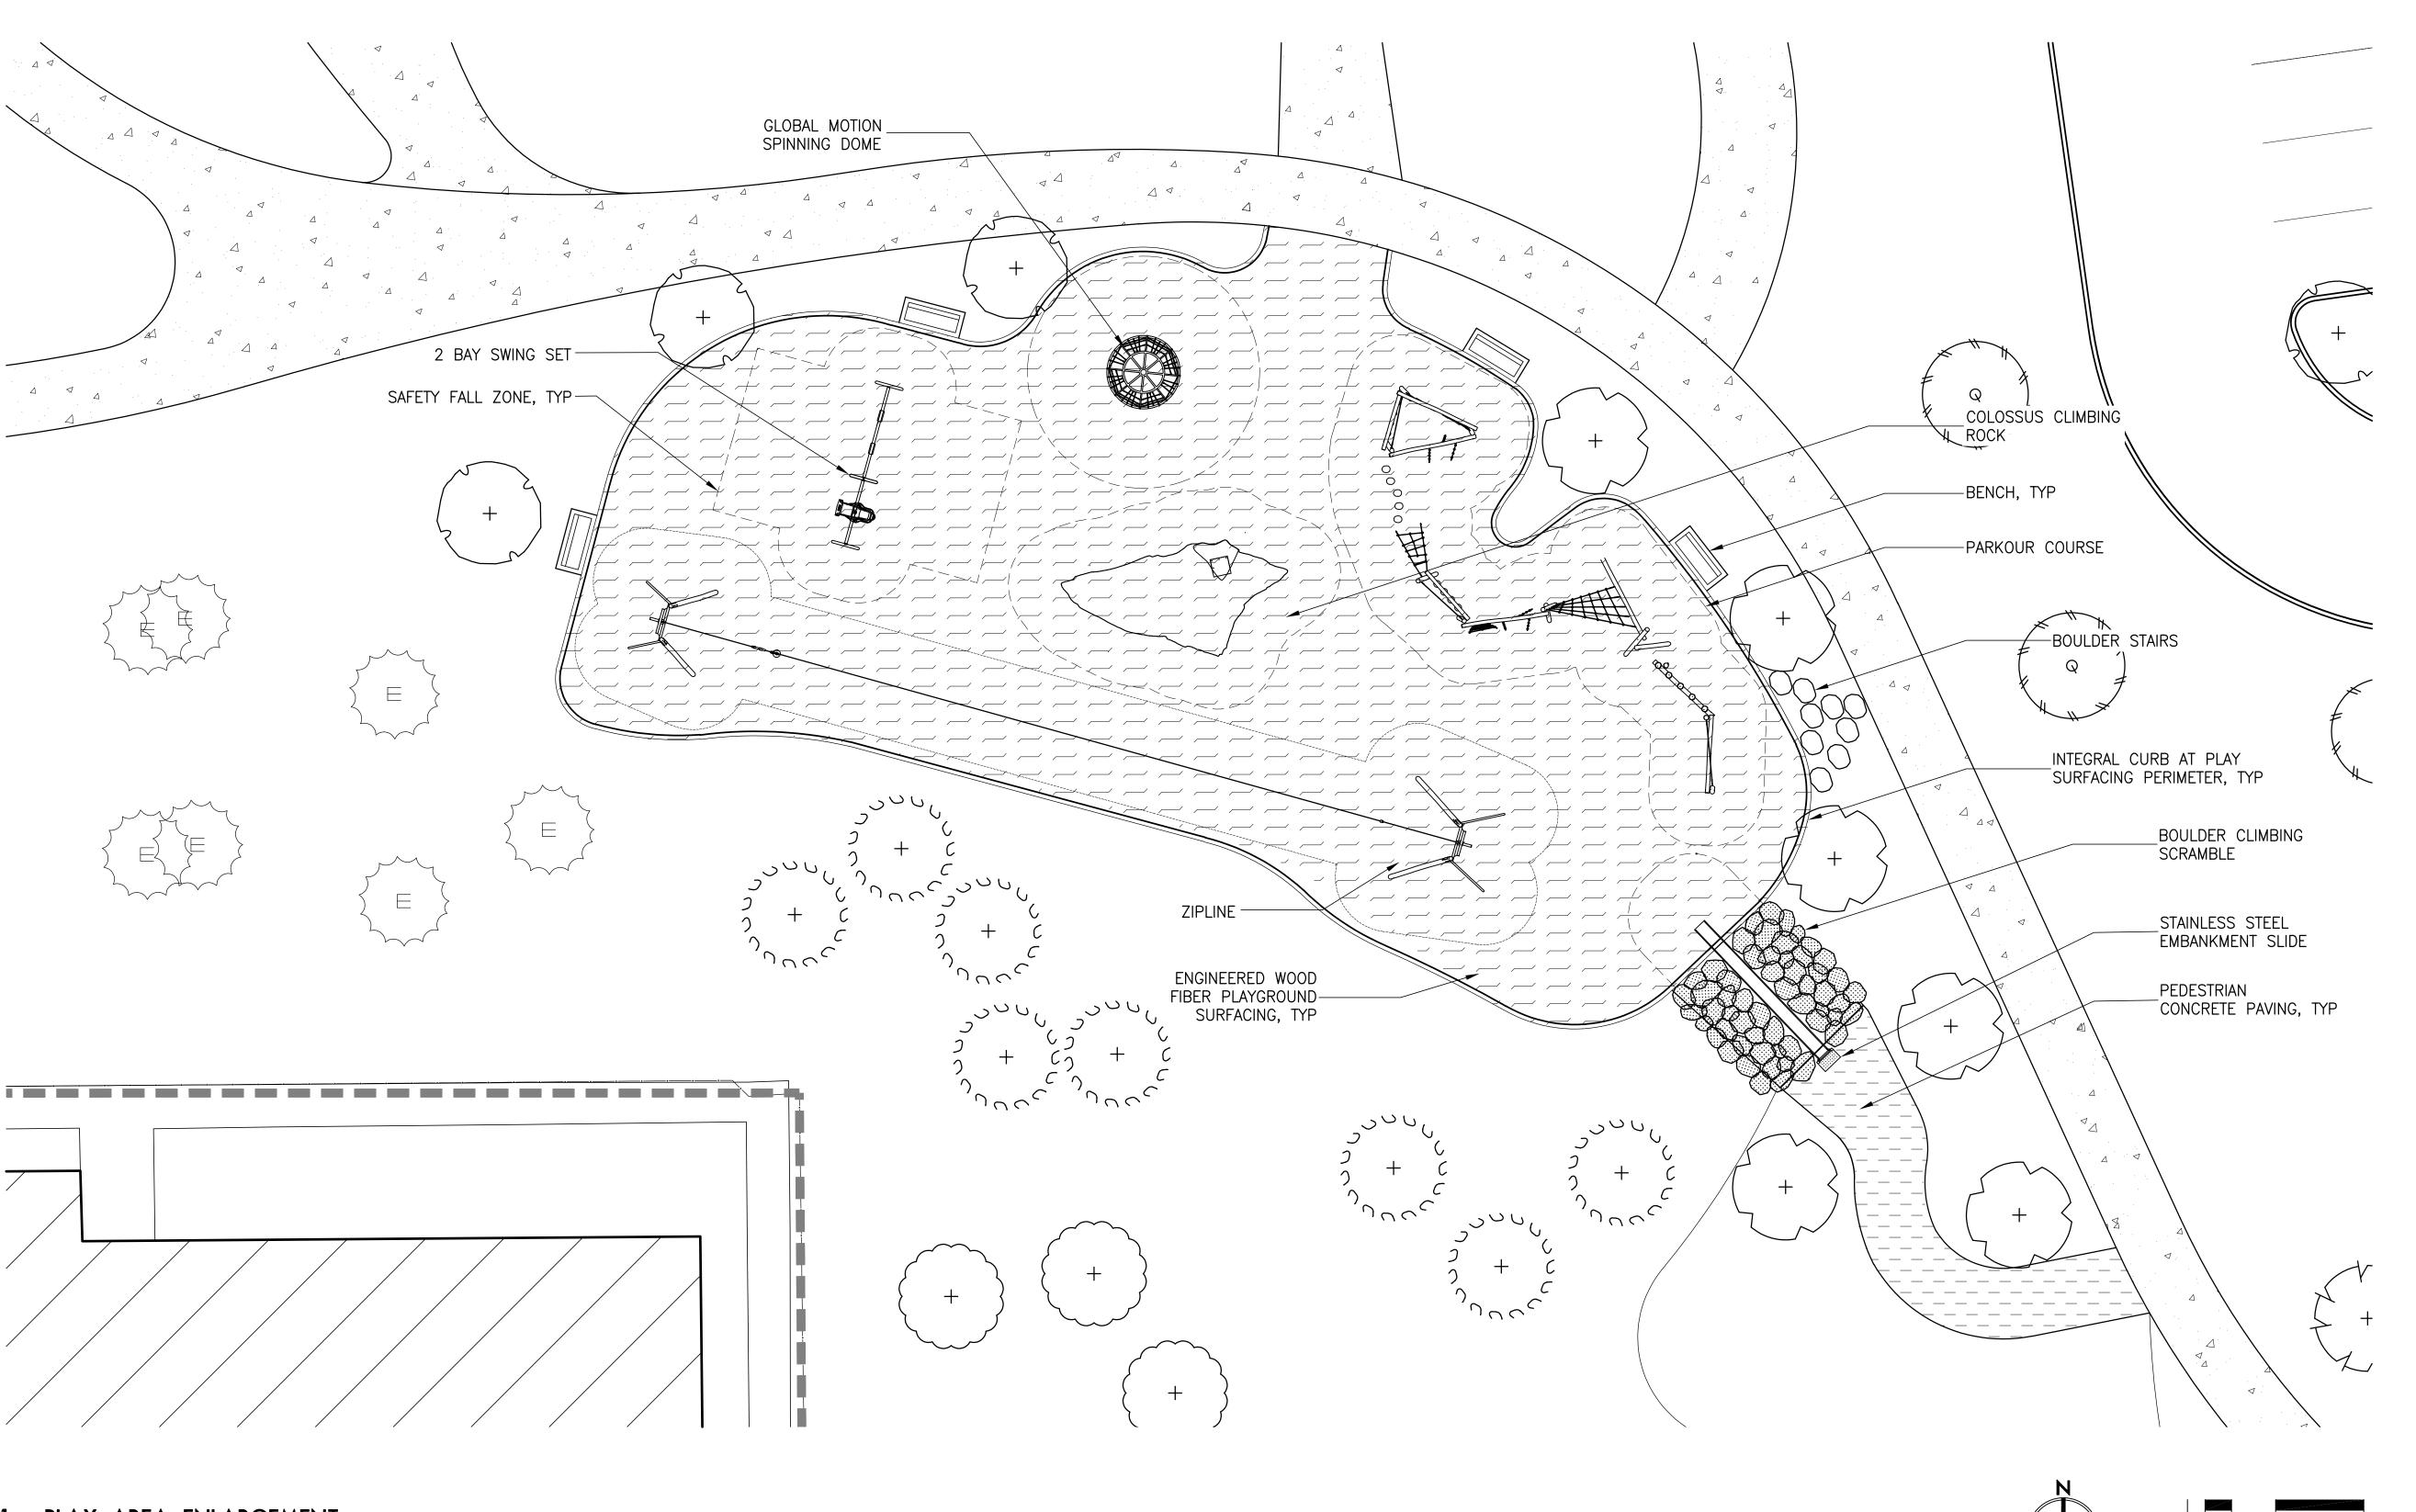TF

ΤW

TYP

TOP OF CURB

TYPICAL

TOP OF FOOTING

TOP OF WALL (FINISHED)

GRADING NOTES

- 1. THIS PLAN IS BASED ON A SURVEY BY 45TH PARALLEL GEOMATICS DATED 02/09/2023. NOTIFY OWNER'S REPRESENTATIVE OF ANY DISCREPANCIES IDENTIFIED ON SITE RELATED TO SURVEY INFORMATION PRIOR TO INSTALLATION.
- 2. PROTECT EXISTING VEGETATION TO REMAIN; SEE SPECIFICATION SECTION 015639 FOR FENCING AND OTHER REQUIREMENTS.
- 3. SET STRAIGHT GRADES BETWEEN GIVEN ELEVATIONS UNLESS OTHERWISE INDICATED.
- 4. GRADE BREAK LINES ARE SHOWN GRAPHICALLY TO ILLUSTRATE DRAINAGE PATTERNS, AND ARE NOT INTENDED TO BE ACTUAL JOINT LINES, UNLESS THEY FALL ON EXPANSION JOINT LOCATIONS.
- 5. SEE CIVIL DRAWINGS FOR UNDERGROUND UTILITIES AND DRAINAGE FEATURES. 6. ENSURE POSITIVE DRAINAGE AWAY FROM ALL
- BUILDINGS AT 1% MIN. 7. SPOT ELEVATIONS TAKE PRECEDENCE OVER
- LANDSCAPE CONTOURS. 8. PROVIDE 1.5% CROSS SLOPE ON ALL PAVED
- WALKS, TYP, EXCEPT AS SHOWN. DO NOT EXCEED 1.8% CROSS SLOPE, EXCEPT AS SHOWN. 9. DO NOT DISTURB AREAS NOT TO BE GRADED.
- 10. THIS GRADING PLAN IS TO BE COORDINATED WITH THE CIVIL STREET PLANS. NOTIFY OWNER'S REPRESENTATIVE IMMEDIATELY OF ANY DISCREPANCIES.


- 11. SEE CIVIL DRAWINGS FOR ALL VEHICULAR AREA IMPROVEMENTS, INCLUDING PAVING, CURBS, CURB RAMPS, DRIVEWAY APRONS, WHEEL STOPS, STRIPING AND SIGNAGE. AS WELL AS VEHICULAR AND PEDESTRIAN PAVING IMPROVEMENTS WITHIN THE RIGHT-OF-WAY.
- 12. DO NOT EXCEED 1.8% SLOPE AT DOOR LANDINGS, EXCEPT AS SHOWN.
- 13. ADJUSTMENTS OF SOFT SWALE AREAS ± 2 " MAY BE NECESSARY TO IMPROVE DRAINAGE. THESE ADJUSTMENTS SHALL BE DONE AT NO COST TO THE OWNER.
- 14. BOTTOM OF WALL (BW) ELEVATIONS EQUAL FINISH SURFACE OF PAVING OR FINISH GRADE, NOT TOP OF FOOTING ELEVATION.
- 15. CONTRACTOR TO VERIFY EXISTING GRADES AT ALL LOCATIONS WHERE NEW PAVING IS MATCHING EXISTING PAVING AND NOTIFY ARCHITECT IMMEDIATELY OF ANY DISCREPANCIES.
- 16. CONCRETE PAVING ELEVATIONS AT BACK OF CURB TO MATCH TOP OF CURB ELEVATIONS. UNLESS OTHERWISE NOTED, SEE CIVIL DRAWINGS FOR CURB ELEVATIONS.
- 17. ALL ADA PARKING STALL AND WALKWAYS TO MEET LOCAL, STATE AND FEDERAL ADA REQUIREMENTS. PRIOR TO FORMING HARD SURFACE MATERIALS, CONTRACTOR TO VERIFY GRADES FOR CURB RAMPS AND PARKING LOT SPACES MEET ADA REQUIREMENTS.



PARK PUMP TRACK AND JUMP-LINE IMPROVEMENTS SHOWN FOR REFERENCE ONLY

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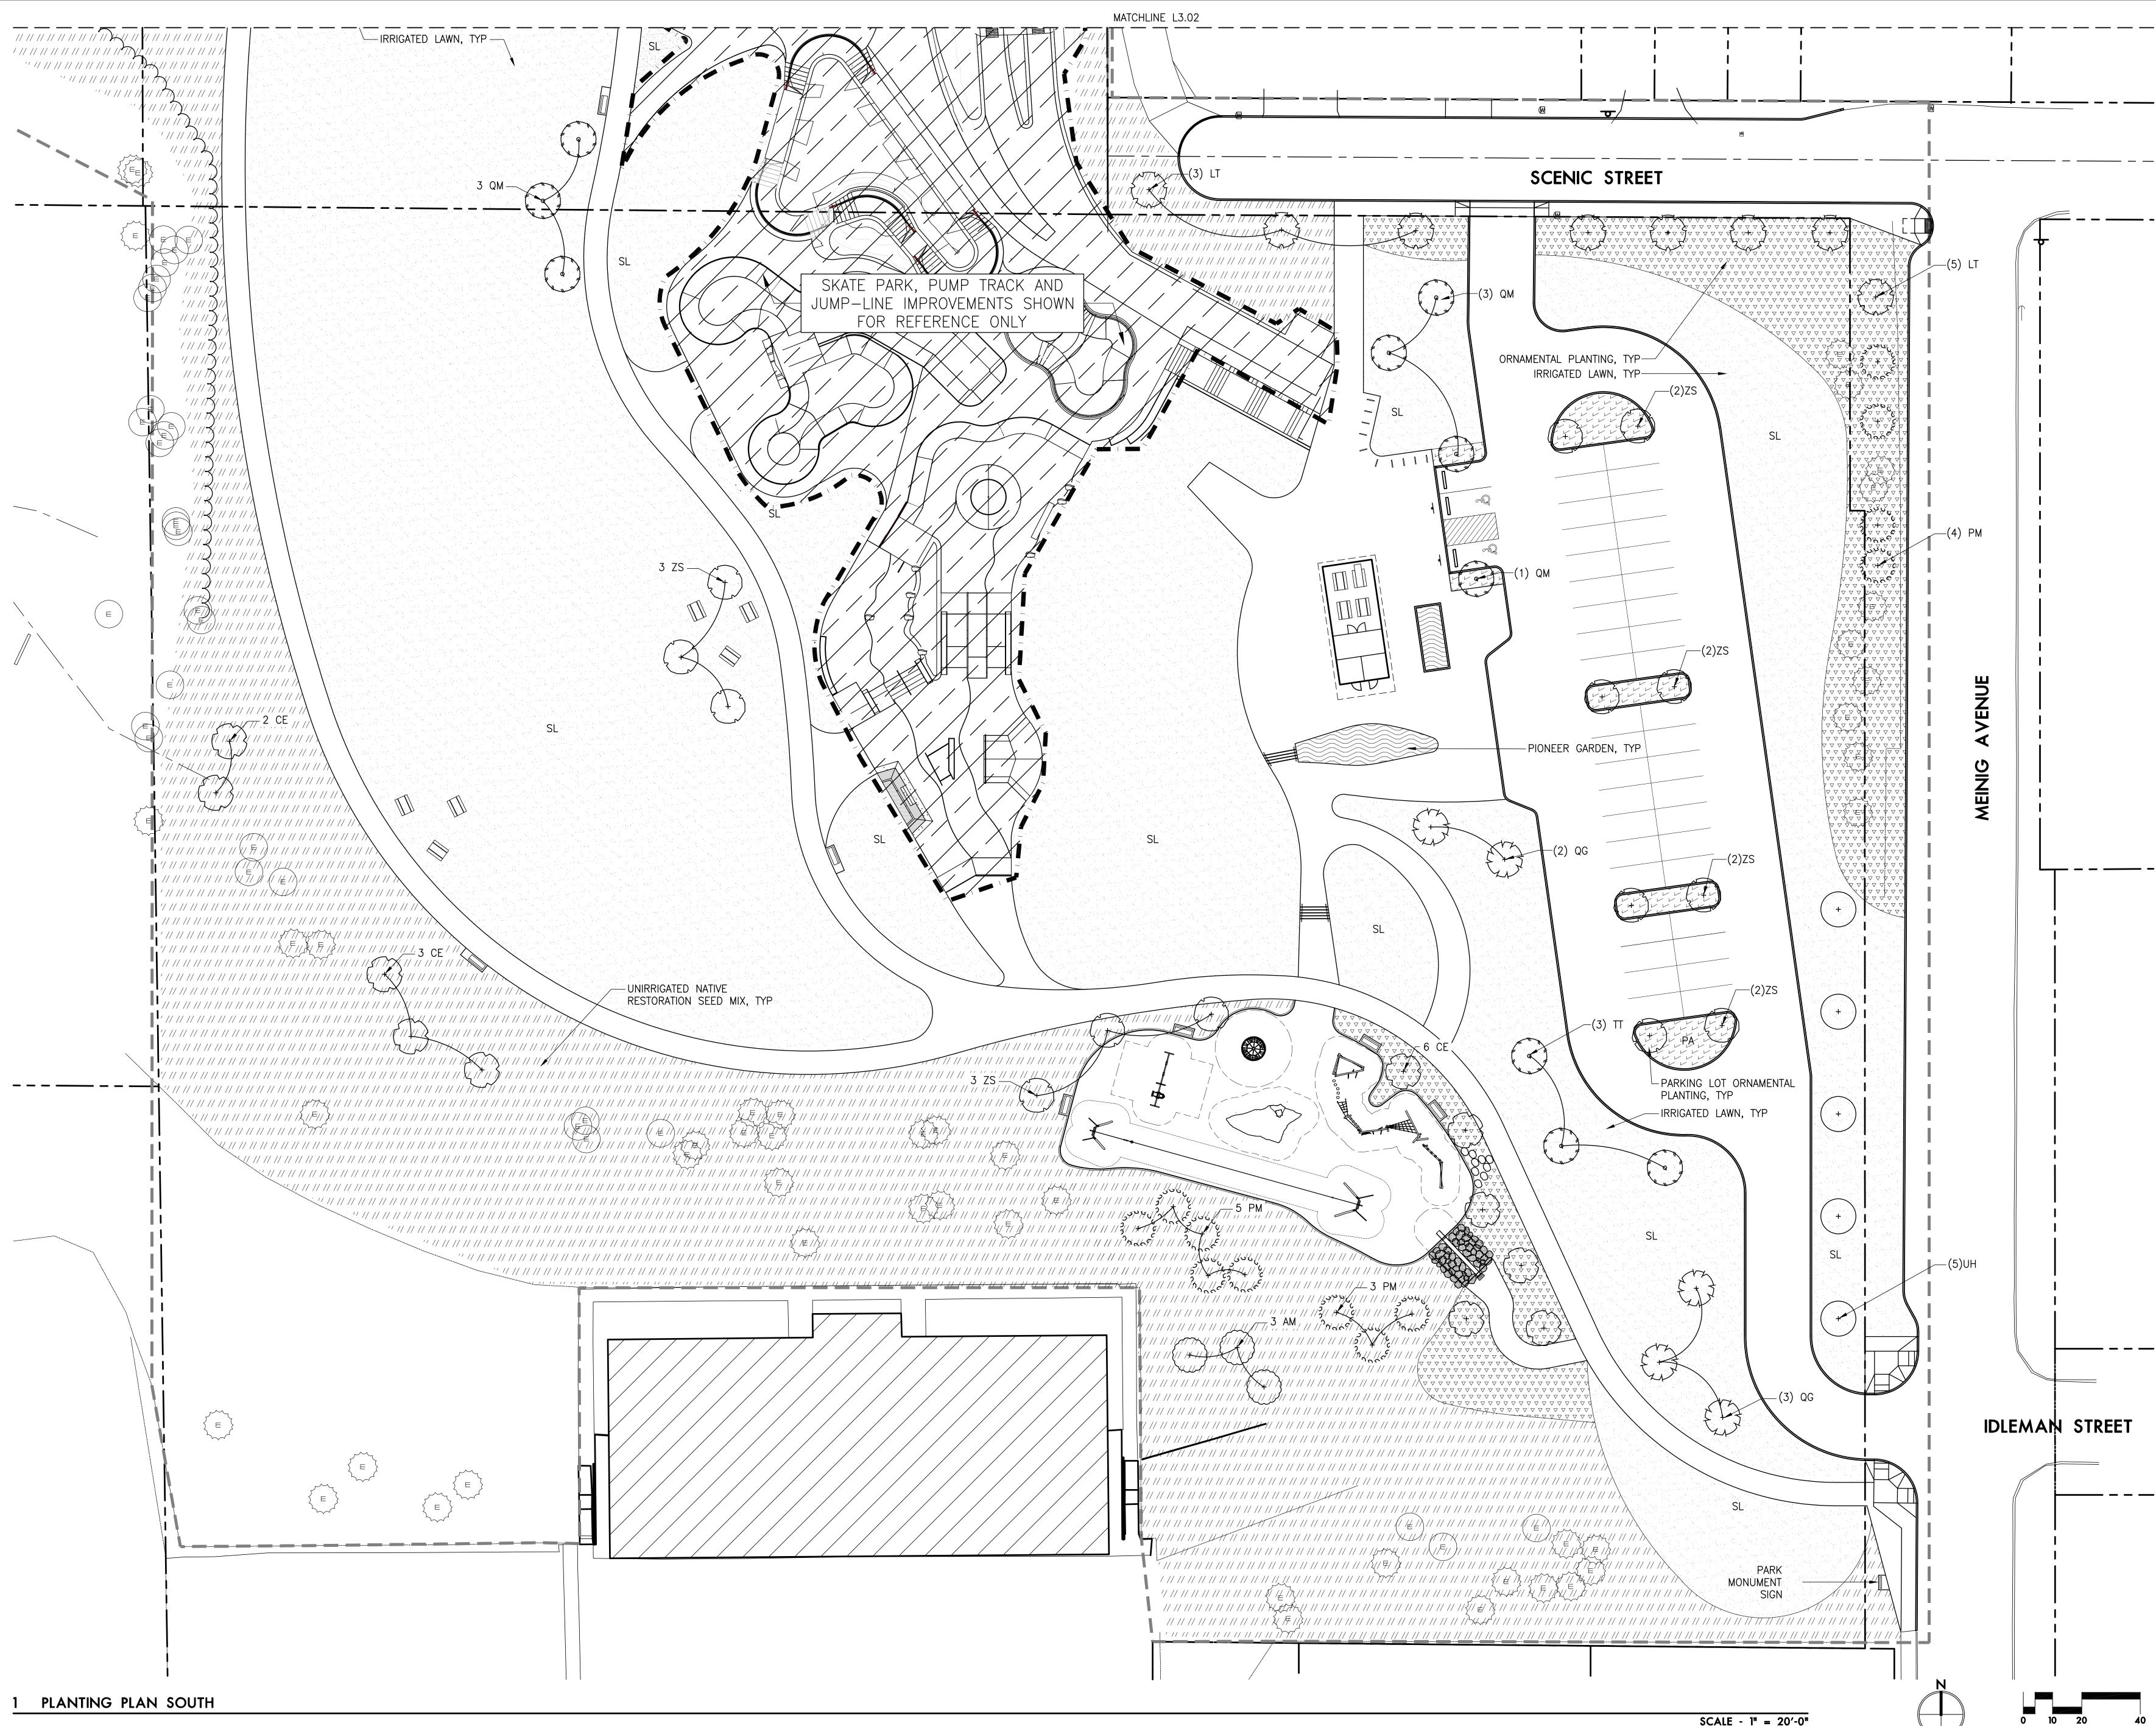


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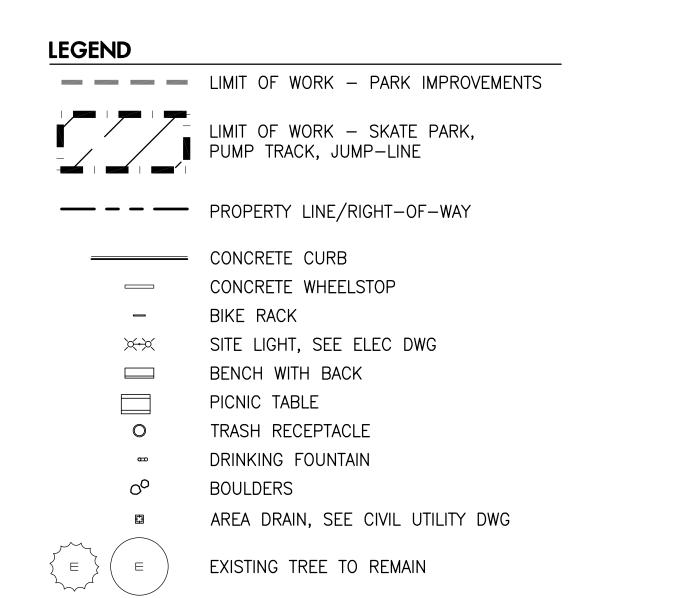
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ABBREVIATIONS

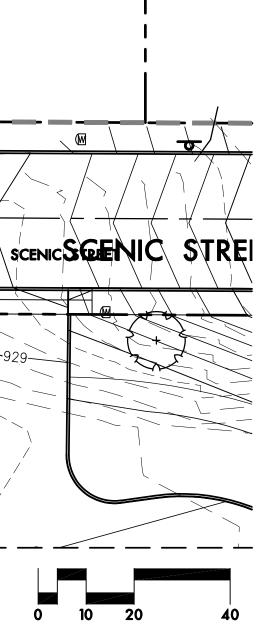	SPECS SPECIFICATIONS TYP TYPICAL # CONTAINER SIZE
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PLANTING NOTES

- 1. THIS PLAN IS BASED ON A SURVEY BY PARALLEL GEOMATICS DATED 02/09/2023. NOTIFY OWNER'S REPRESENTATIVE OF ANY DISCREPANCIES IDENTIFIED ON SITE RELATED TO SURVEY INFORMATION PRIOR TO INSTALLATION.
- 2. PROTECT EXISTING VEGETATION TO REMAIN; SEE SPECIFICATION SECTION 015639 FOR FENCING AND OTHER REQUIREMENTS.
- 3. ALL PLANT MATERIAL SHALL BE NURSERY GROWN, WELL ROOTED, AND WELL BRANCHED. ALL TREES MUST BE FREE OF INSECTS, DISEASES, MECHANICAL INJURY, AND OTHER OBJECTIONABLE FEATURES WHEN PLANTED. ALL PLANT MATERIAL SHALL CONFORM TO "AMERICAN STOCK STANDARDS" LATEST EDITION.
- 4. ALL PLANT MATERIAL TO BE APPROVED BY OWNER'S REPRESENTATIVEPRIOR TO INSTALLATION. SEE SPECIFICATIONS.
- 5. PLANT SPACING SHALL TAKE PRECEDENCE OVER VALVE BOX LOCATIONS. INSTALLED VALVE BOXES THAT CONFLICT WITH ACCEPTED PLANT LAYOUT SHALL BE MOVED TO POSITION BETWEEN PLANTS.
- 6. PLANT COUNTS FOR TREES AND SHRUBS ARE SUPPLIED FOR THE CONTRACTOR'S CONVENIENCE. CONTRACTOR RESPONSIBLE

AND QUANTITIES SHOWN. FOR GROUNDCOVER PLANTING, SEE DETAIL _/L___.

- 7. CLEAR PLANT BEDS OF ALL GRAVEL AND DEBRIS PRIOR TO SOIL PREPARATION AND PLANTING, FOR APPROVAL BY OWNER'S REPRESENTATIVE.
- 8. REPAIR AND RESEED ALL LAWN AREAS DISTURBED BY CONSTRUCTION ACTIVITY, INCLUDING SOIL PREPARATION. SEE 329100 AND 329300.
- 9. ALL LANDSCAPE AREAS THAT HAVE A SLOPE GREATER THAN 1 VERTICAL FOOT IN 3 HORIZONTAL FEET SHALL RECEIVE JUTE MATTING, SEE SPECIFICATIONS.
- 10. ALL PARKING LOT AND STREET TREES MUST HAVE 6' CLEAR HEIGHT TO LOWEST BRANCHES.
- 11. ALL PLANTING AREAS TO BE IRRIGATED WITH A PERMANENT IRRIGATION SYSTEM EXCEPT FOR AREAS TO BE SEEDED WITH RESTORATION SEED MIX. THESE AREAS TO BE MANUALLY WATERED TO ENSURE ESTABLISHMENT.



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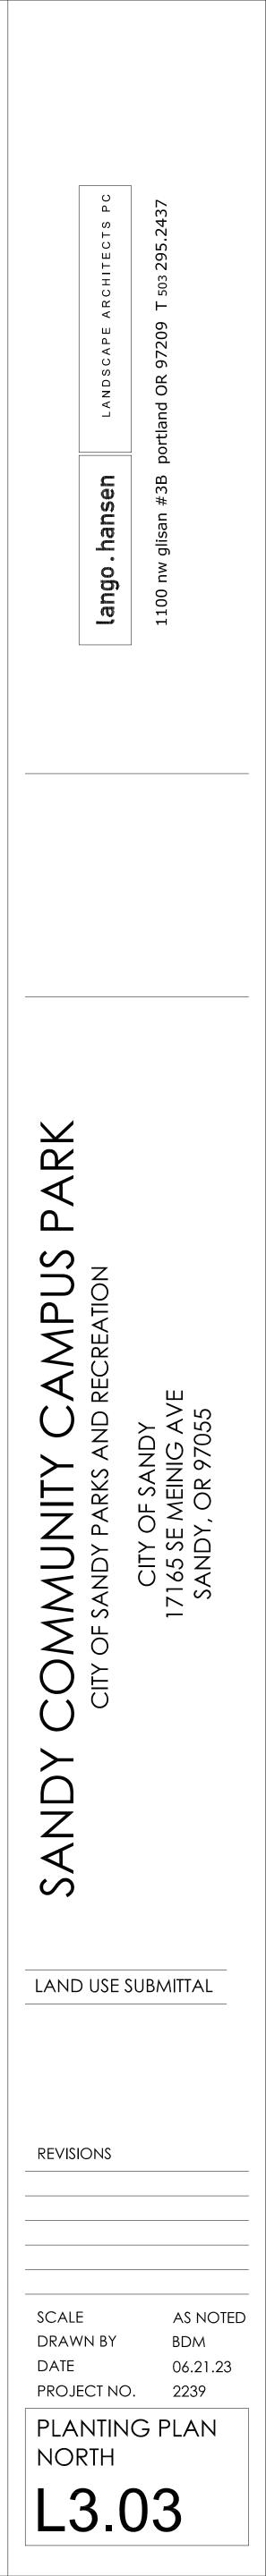
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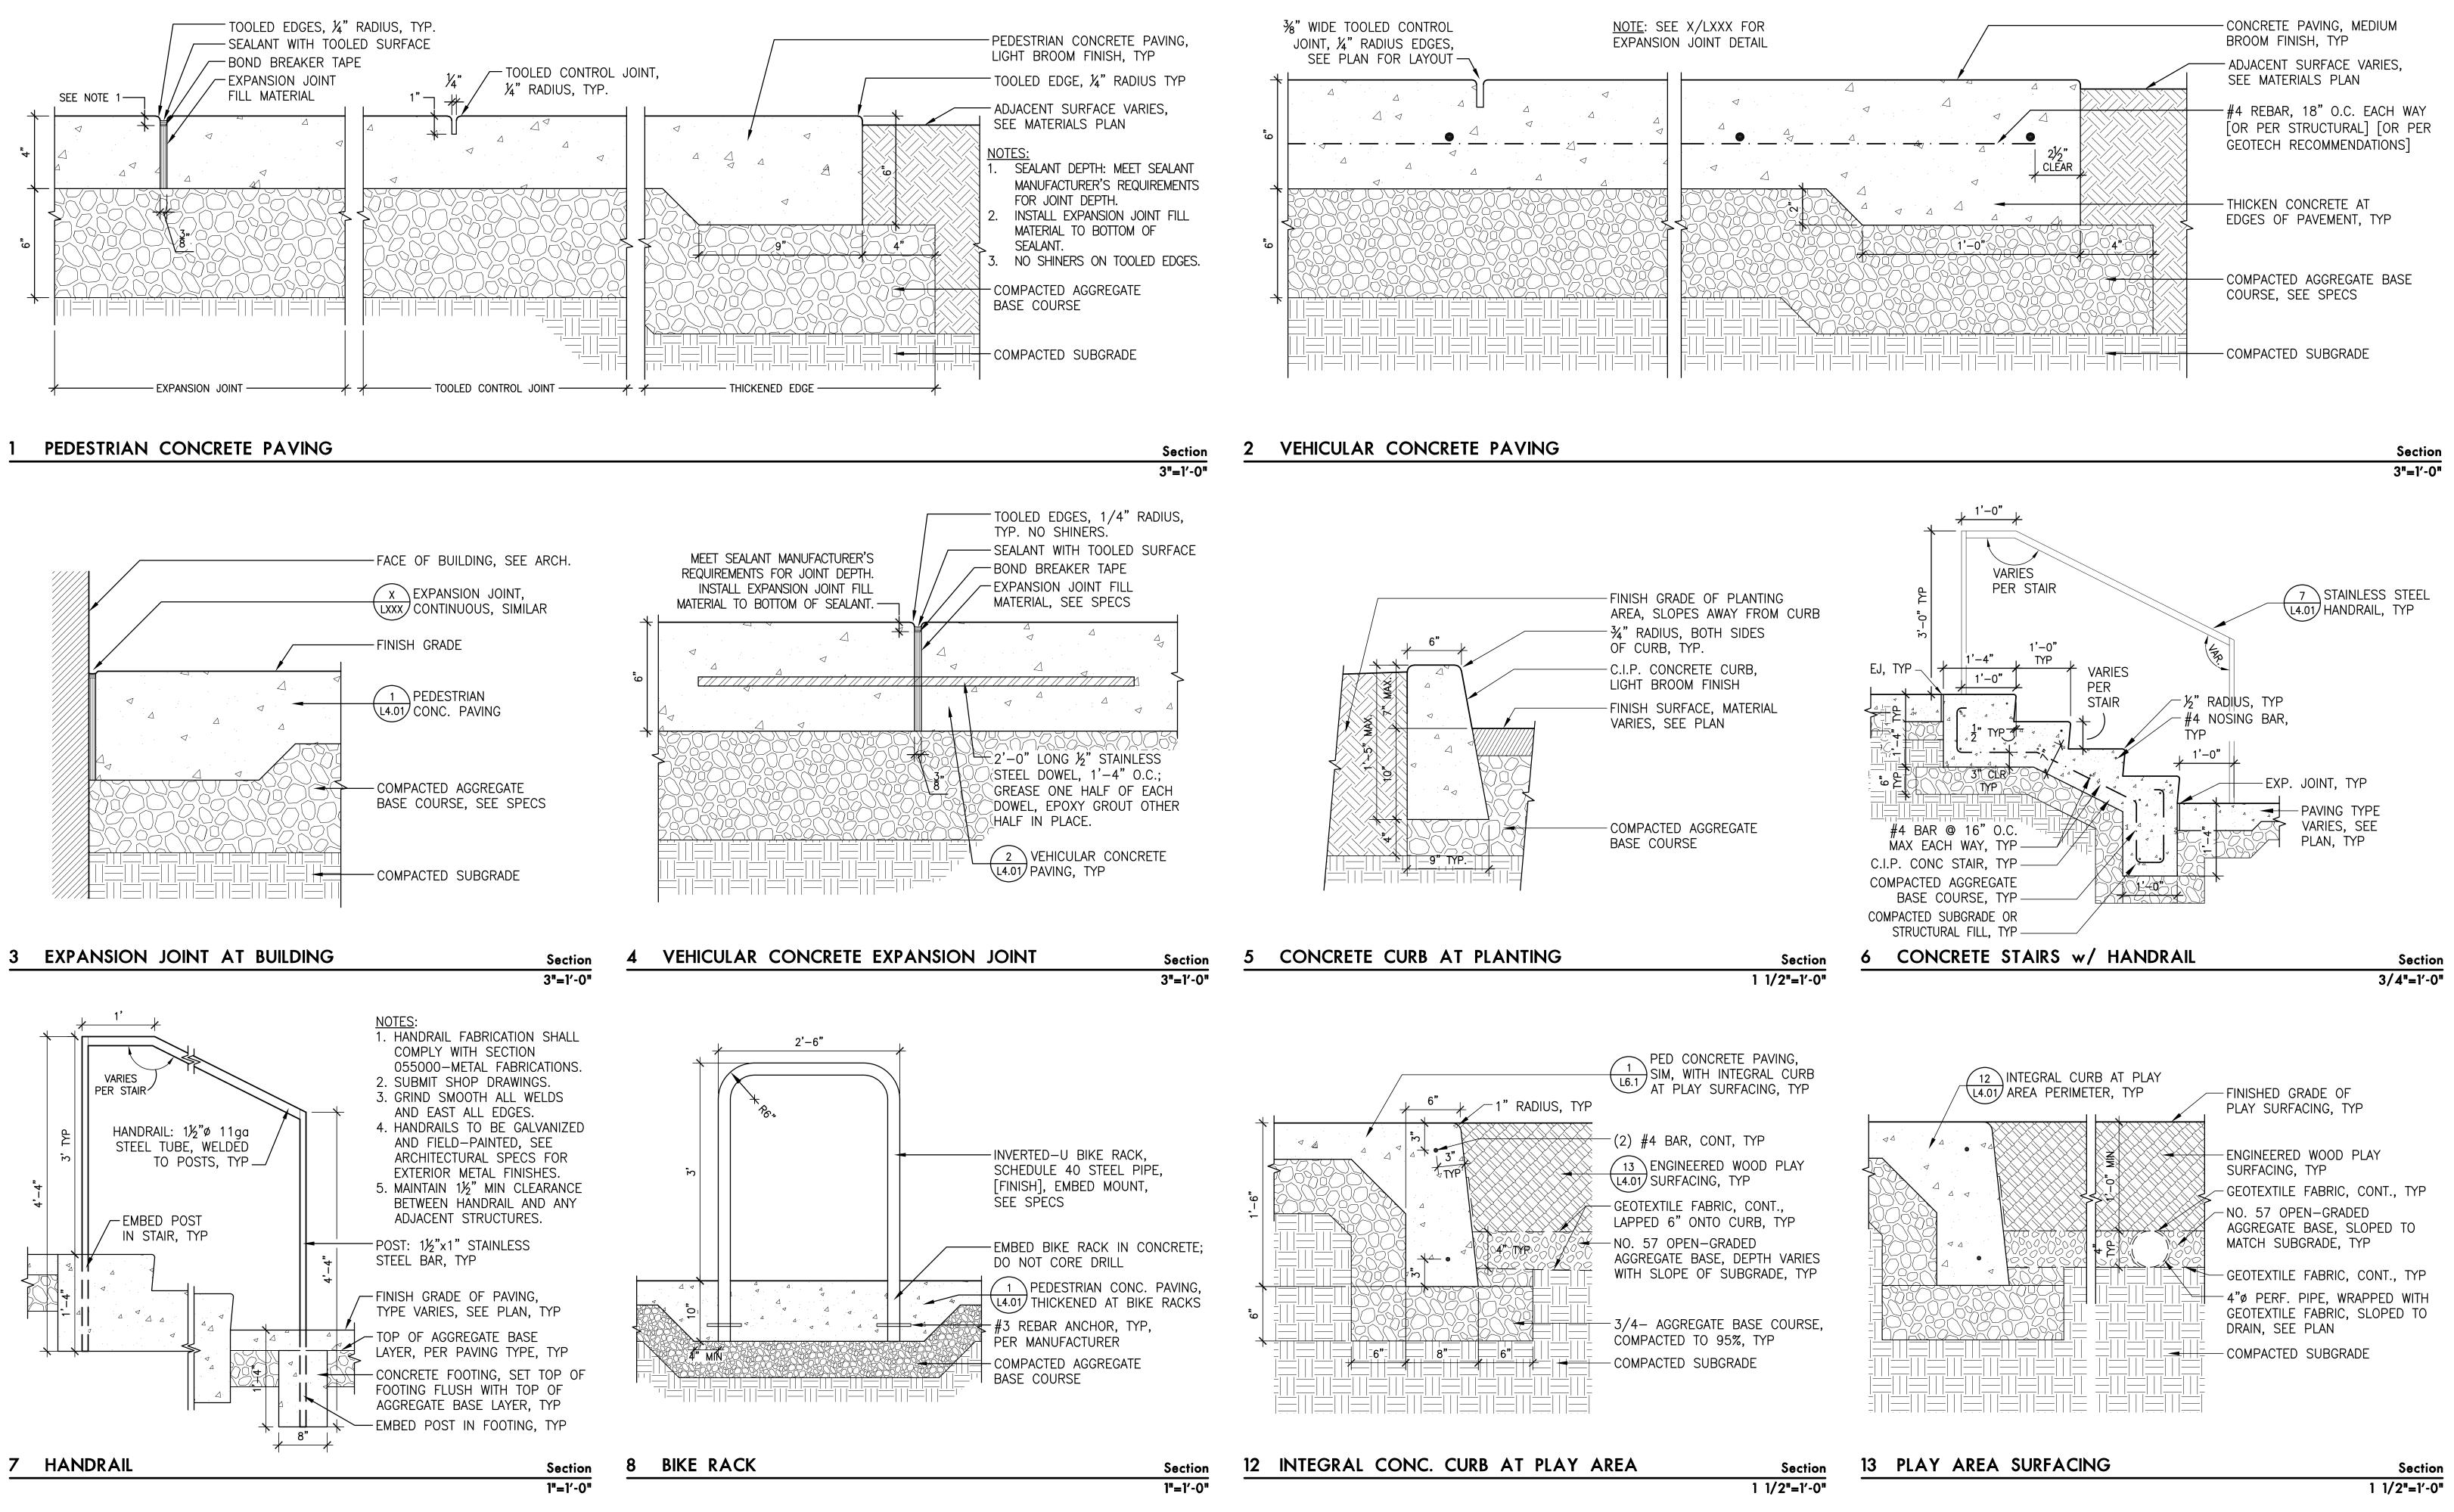
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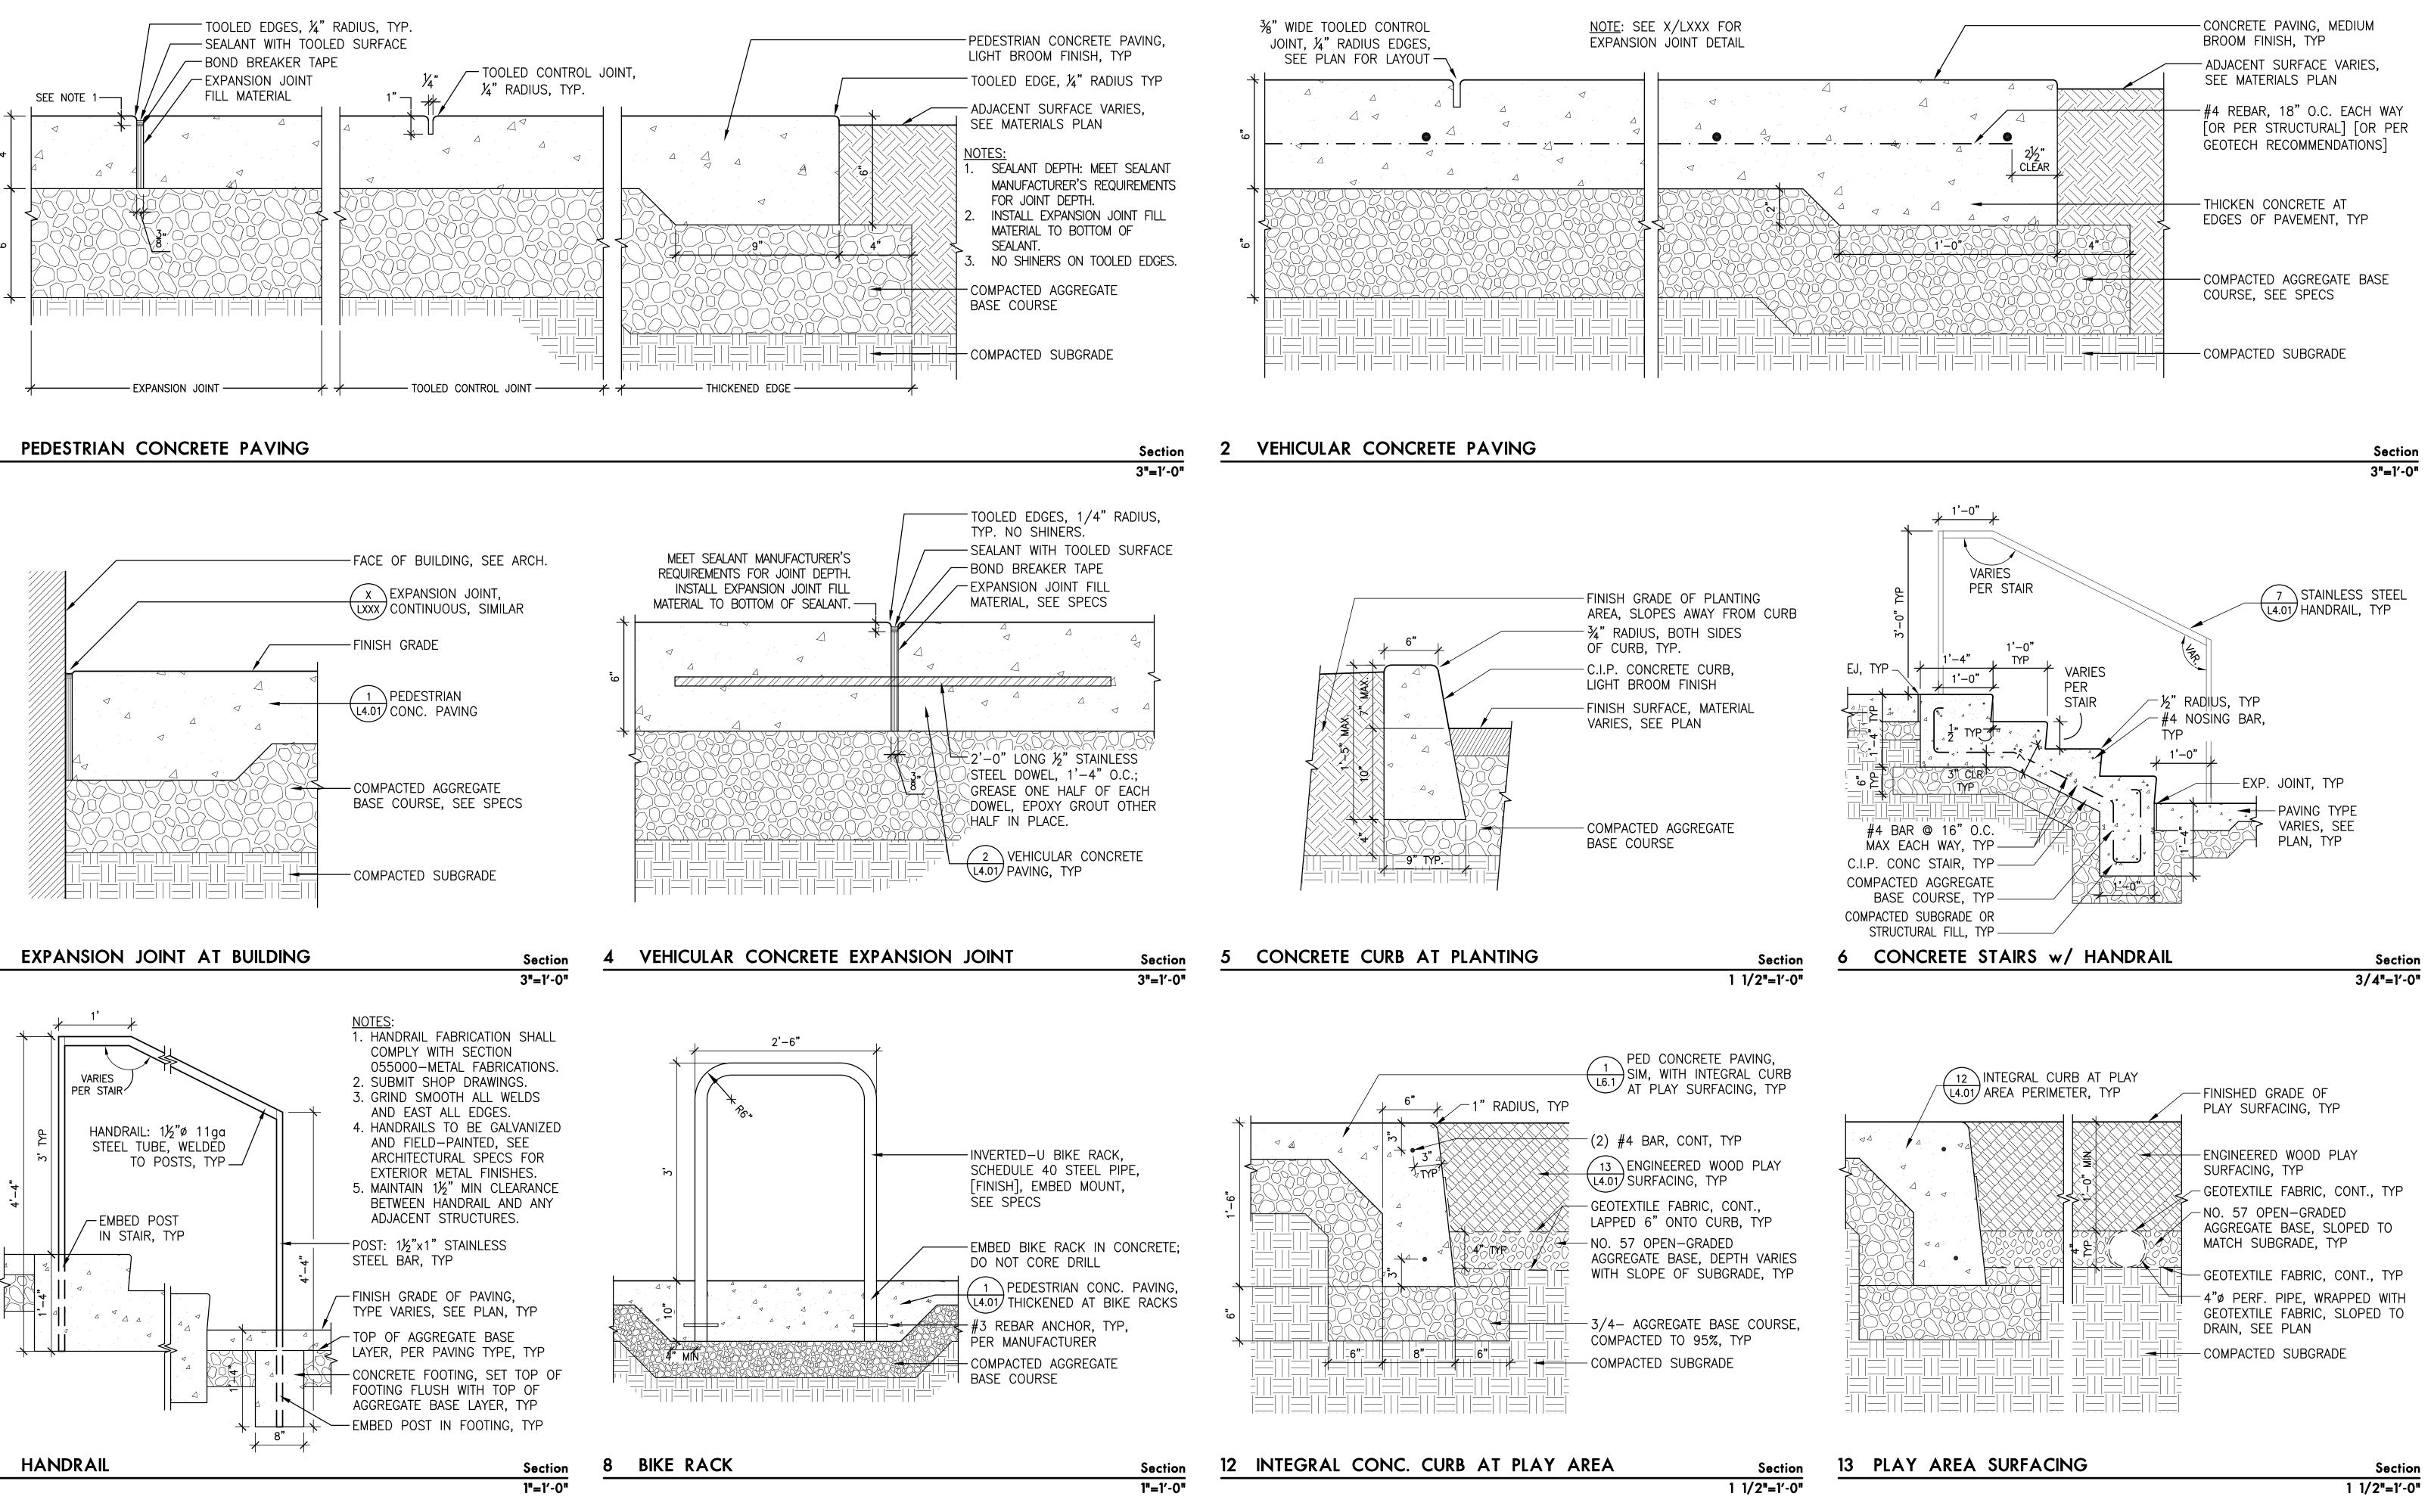
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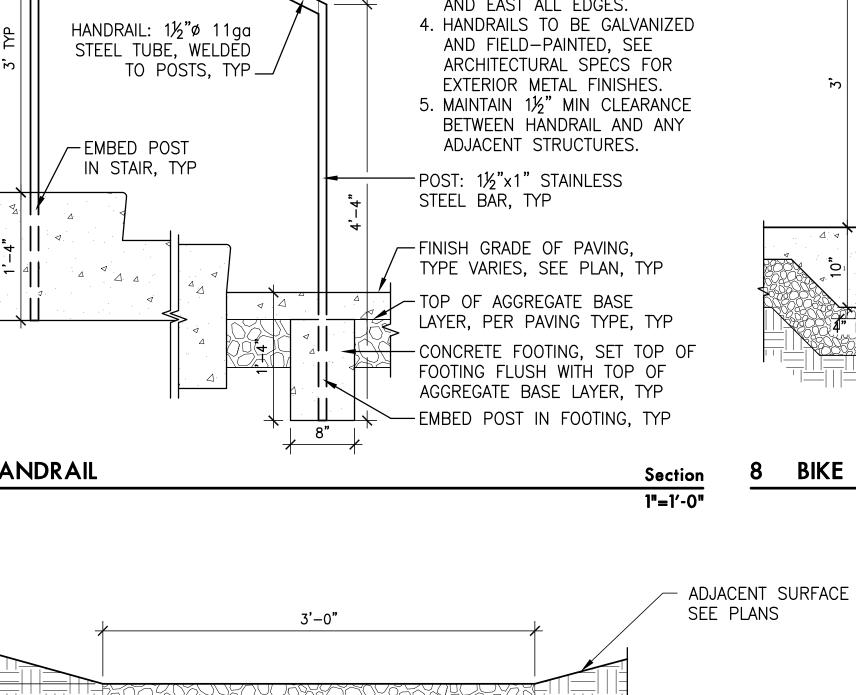
PLANT SCHEDULE SYMBOL ABBR BOTANICAL NAME TREES Acer macrophyllum { + } AM \sim \sim Cornus ×elwinortonii 'Starlight' $\left(+ \right)$ CE \sim Nh $\left\{ + \right\}$ Liriodendron tulipifera LT 2~5 , 3¹⁰ 10/1 Pseudotsuga menziesii PM ى^{ر ر}ر + Quercus acutissima QA \sim M $\frac{2}{7}$ + $\frac{1}{7}$ QG Quercus garryana 1 AN A Th Tilia tomentosa 'Sterling' | TT (+) Ulmus 'Homestead' UH \searrow Zelkova serrata 'Village Green' ZS + \smile ORNAMENTAL SHRUBS AND GROUNDCOVERS Ligustrum japonicum LIJA Lonicera pileata MARE Mahonia repens Philadelphus lewisii PHLE PHCA Physocarpus capitatus POMU Polystichum munitum PIONEER GARDEN ACMO Achillea x 'Moonshine' CICO Cistus corbariensis CLSP Cleome spinosa LAAN Lavandula angustifolia 'Hidcote' PEOV Penstemon ovatus Rosmarinus officinalis 'Blue Boy' ROOF Spiraea betulifolia 'Tor' SPBE PARKING LOT PLANTING ARUV Arctostaphylos uva-ursi レレレレ llex crenata 'Helleri' ILCR PEAL Pennesitum alopecuroides 'Little Bunny' SEED MIXES || || || || || || || Hopkins and Hobbs Conventional Lawn Seed Mix - PT 305 Shade/Sun Mix


	COMMON NAME	SIZE/CONDITION	SPACING
		,	
	Bigleaf Maple	3" CAL., B&B	as shown
	Starlight Dogwood	3" CAL., B&B	as shown
	Tulip Tree	3" CAL., B&B	as shown
	Douglas Fir	8'HT., B&B	as shown
	Sawtooth Oak	3" CAL., B&B	as shown
	Oregon White Oak	3" CAL., B&B	as shown
	Sterling Silver Linden	3" CAL., B&B	as shown
	Homestead Elm	3" CAL., B&B	as shown
	Village Green Zelkova	3" CAL., B&B	as shown
	Japanese Privet	#5 CONT	42" O.C.
	Privet Honeysuckle	#5 CONT	42" O.C.
	Creeping Oregon Grape	#1 CONT	18" O.C.
	Western Mock Orange	#5 CONT	48" O.C.
	Pacific Ninebark	#5 CONT	60" O.C.
	Sword Fern	#2 CONT	30" O.C.
	Moonshine Yarrow	#1 CONT	30" O.C.
	White Rock Rose	#5 CONT	30" O.C.
	Spider Flower	#1 CONT	30" O.C.
	Hidcote Lavender	#2 CONT	30" O.C.
	Broadleaf Penstemon	#1 CONT	30" O.C.
	Blue Boy Dwarf Rosemary	#2 CONT	30" O.C.
	Birchleaf Spirea	#1 CONT	30" O.C.
	Kinnikinnick	#1 CONT	30" O.C.
	Dwarf Japanese Holly	#5 CONT	30" O.C.
	Little Bunny Fountain Grass	#2 CONT	30" O.C.
Jpland Mix			
	Shade /Sun Mix		










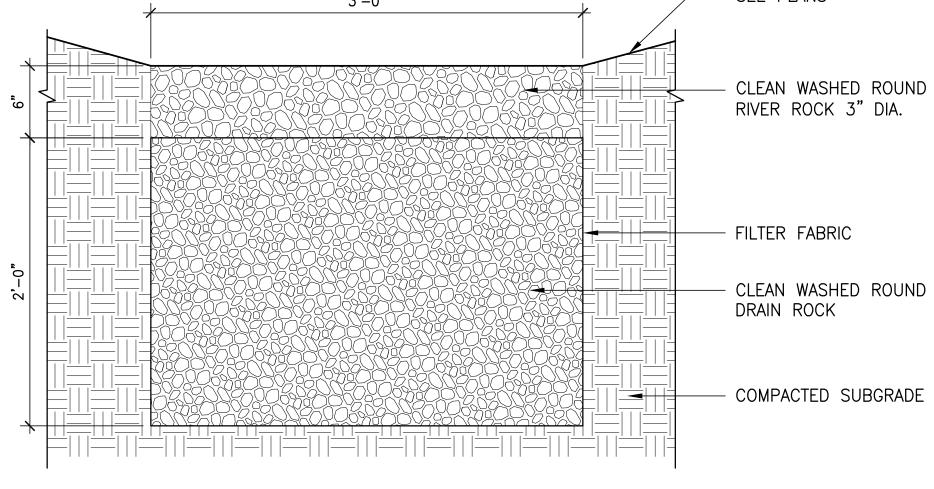

¹⁴ DRYWELL

Section 1 1/2"=1'-0"



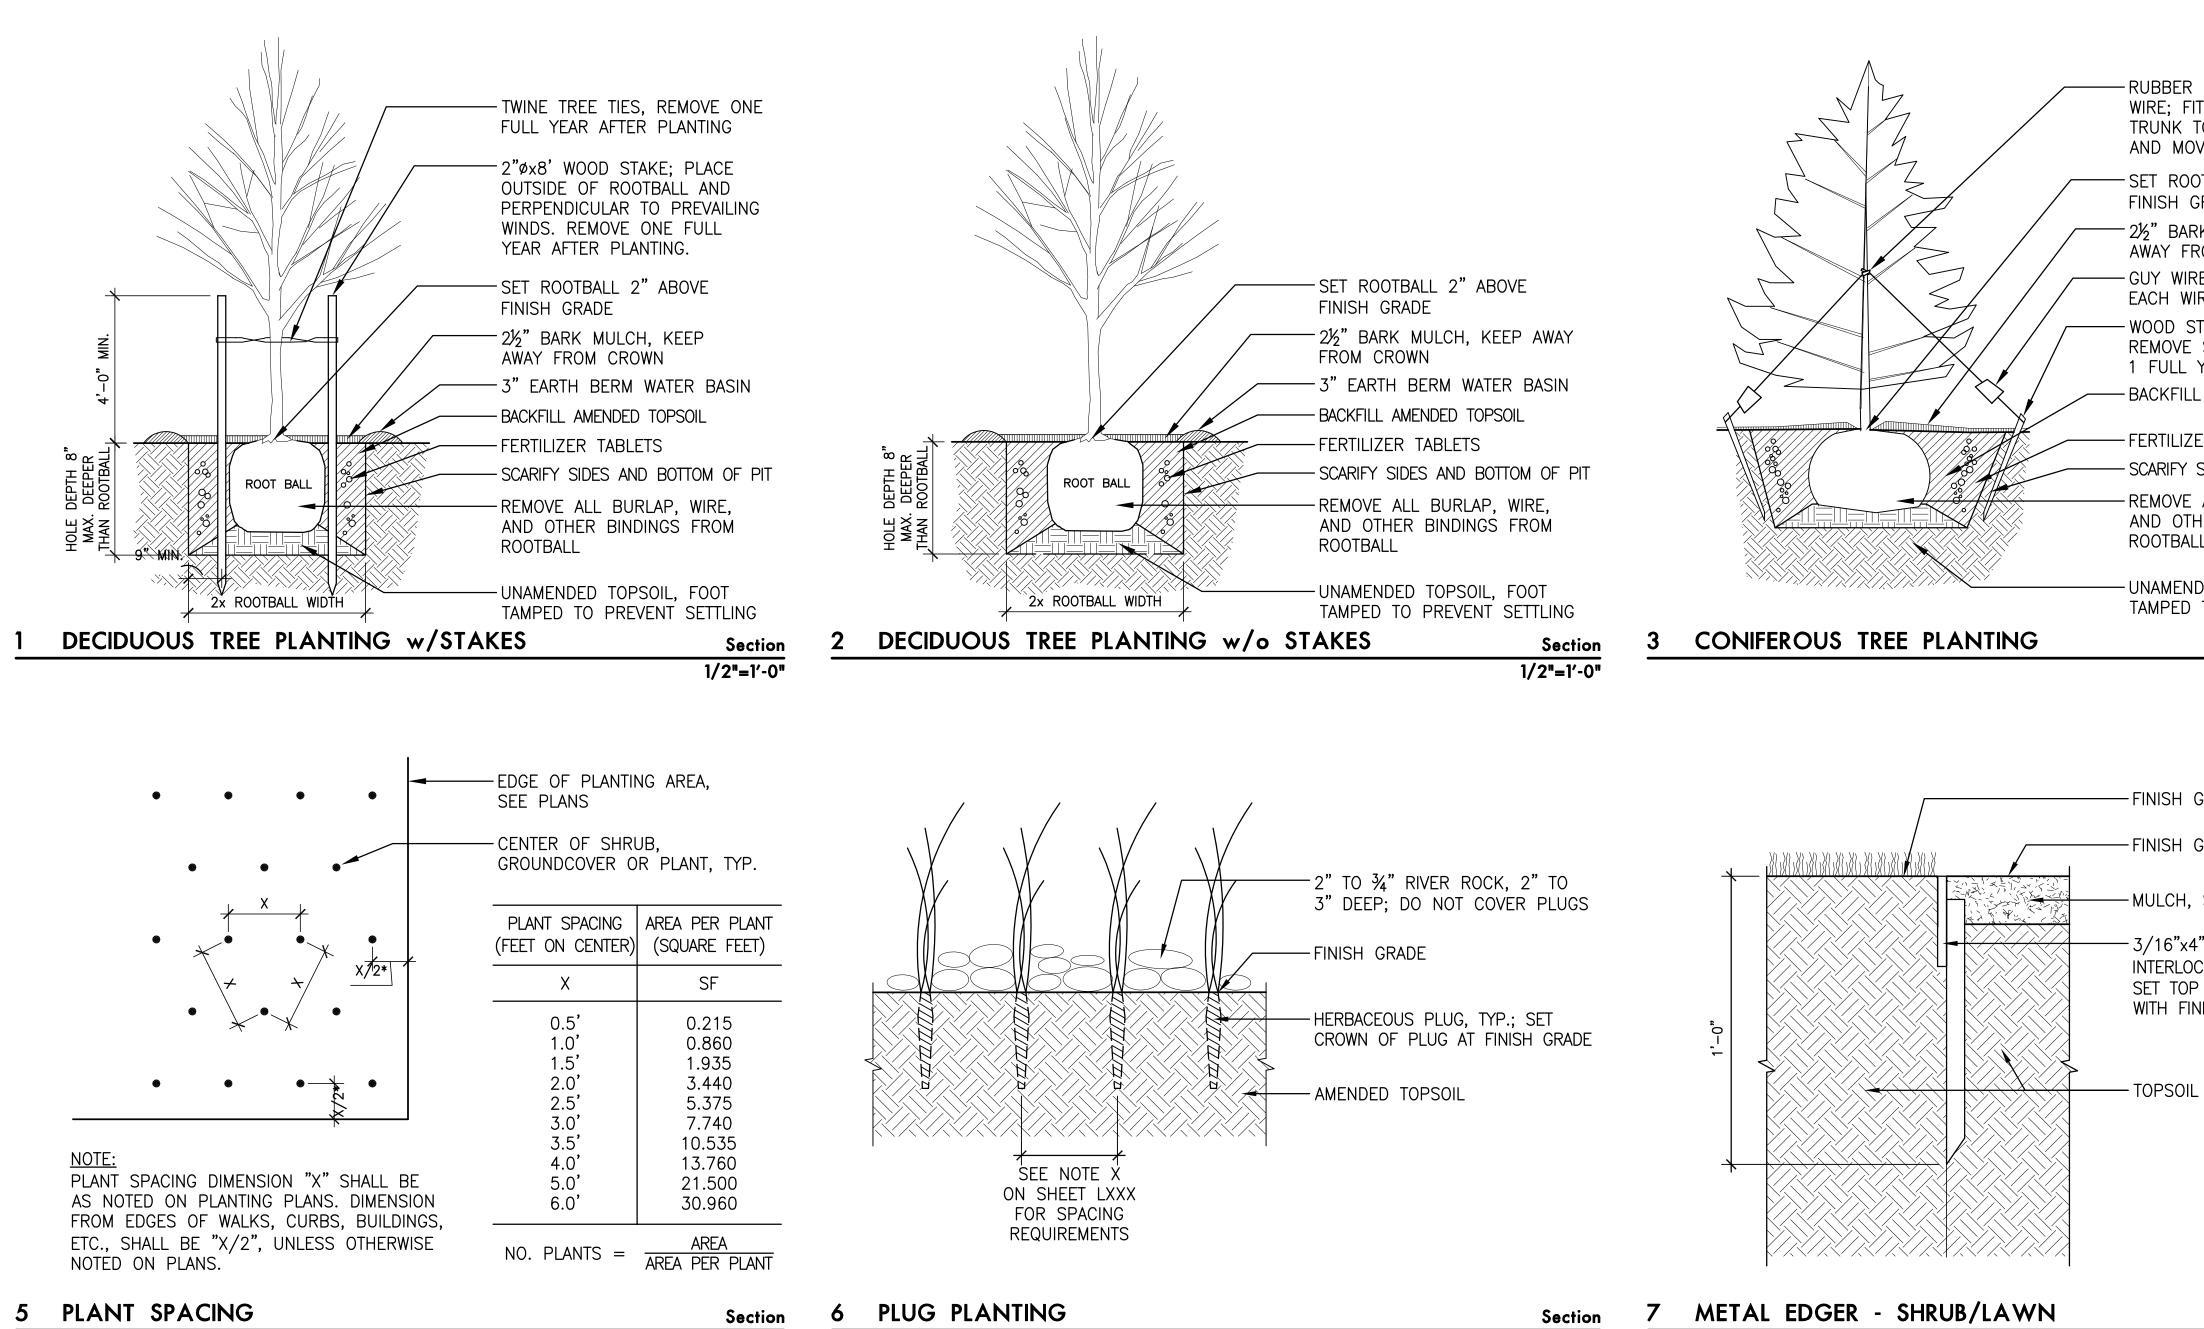

1/2"=1'-0"

3"=1'-0"

METAL EDGER - SHRUB/LAWN

-RUBBER COLLAR FOR EACH GUY WIRE; FIT LOOSELY AROUND TRUNK TO ALLOW FOR GROWTH AND MOVEMENT OF TREE

- SET ROOTBALL CROWN 3" ABOVE FINISH GRADE - 2½" BARK MULCH, KEEP

AWAY FROM CROWN

EACH WIRE, SEE SPECS - WOOD STAKE, SEE SPECS. REMOVE STAKES AND TIES 1 FULL YEAR AFTER PLANTING

- BACKFILL AMENDED TOPSOIL - SCARIFY SIDES AND BOTTOM OF PIT -REMOVE ALL BURLAP, WIRE, AND OTHER BINDINGS FROM ROOTBALL

- UNAMENDED TOPSOIL, FOOT TAMPED TO PREVENT SETTLING

Section 1/2"=1'-0" DEEPE BALL

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4 SHRUB PLANTING

Section 1"=1'-0"

- PLANT ROOTBALL CROWN 1"

- BACKFILL AMENDED TOPSOIL

- SCARIFY SIDES AND BOTTOM

-UNAMENDED TOPSOIL. FOOT-

TAMPED TO PREVENT SETTLING

2½" BARK MULCH, TAPERED TO

ABOVE FINISH GRADE

ROOTBALL CROWN

OF PLANTING PIT

SUBGRADE

-FINISH GRADE, LAWN

MULCH, SEE SPECS


- 3/16"x4" STEEL HEADER WITH INTERLOCKING STAKE 2'-0" O.C.; SET TOP OF HEADER AT FLUSH WITH FINISH GRADE OF LAWN

NOTES: 1. EXISTING SOIL CHEMISTRY SHALL NOT BE ALTERED BY CONSTRUCTION ACTIVITIES. CHEMICAL WASTES AT CONSTRUCTION SITE SHALL BE DISPOSED OF PROPERLY AND NOT DRAINED ONTO SOIL 2. CONSTRUCTION FENCING SHALL BE PLACED BEFORE CONSTRUCTION STARTS AND REMAIN IN PLACE UNTIL CONSTRUCTION HAS BEEN COMPLETED.

ROOT BALL


2x DIAMETER


OF ROOTBALL

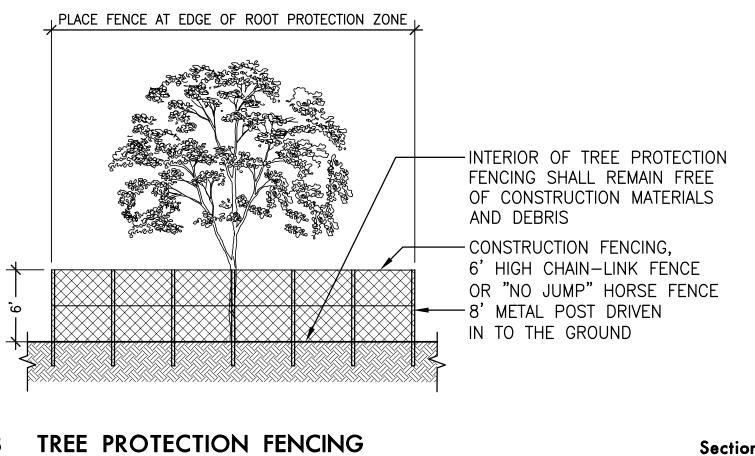

Section 3"=1'-0"

Section NTS

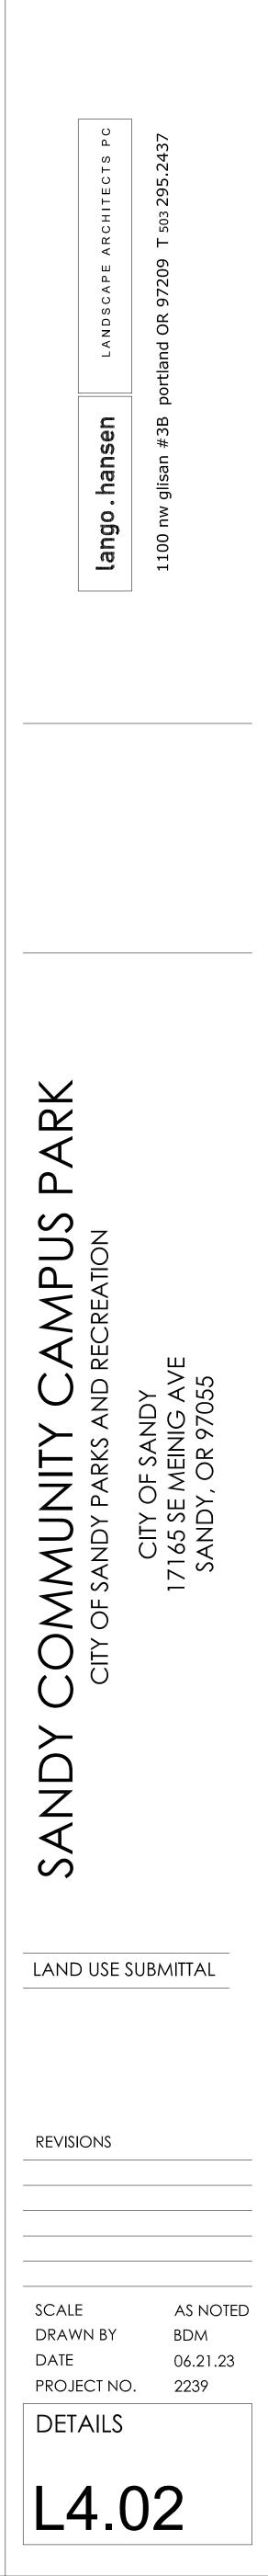

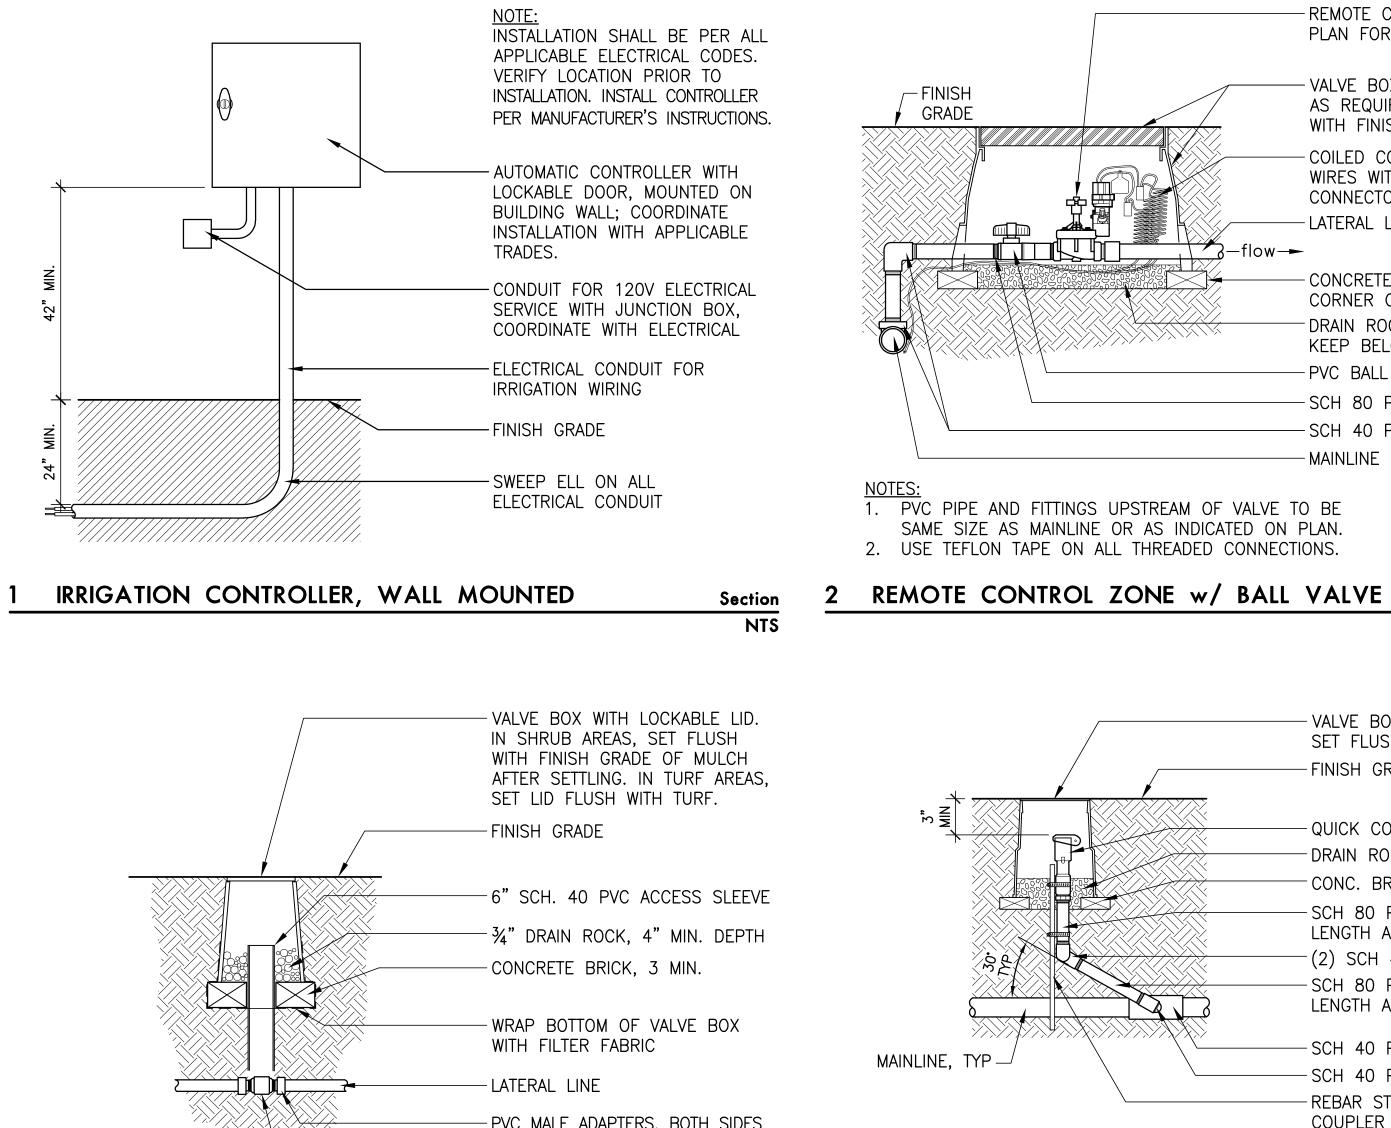

Section

NTS

- PVC MALE ADAPTERS, BOTH SIDES -SWING CHECK VALVE, LINE SIZE

5 SWING CHECK VALVE

NOTE: DO NOT VERTICALLY STACK MAINLINE AND LATERAL LINE. 3" - FINISH GRADE MIN SEPARATION REQUIRED - ADJACENT MATERAL, SEE PLAN ╵┶╤╤┼┴ - SPECIFIED BACKFILL -LATERAL LINE, SEE PLAN FOR SIZE $\overline{\mathbf{O}}$ - TRACER WIRE AS SPECIFIED -MAINLINE, SEE PLAN FOR SIZE -BUNDLED REMOTE CONTROL 3" MIN VALVE WIRES BESIDE/BELOW MAINLINE ON OPPOSITE SIDE OF SWING JOINTS, TYP.


9 IRRG TRENCH 10 IRRG SLEEVE Section NTS -LOCKABLE VALVE BOX LID -FINISH GRADE VALVE BOX AND EXTENSIONS AS REQUIRED; SET TOP OF BOXES FLUSH WITH FINISH GRADE - PIPE FROM BACKFLOW, SEE CIVIL -GATE VALVE, LINE SIZE - RAINBIRD TBOS-II CONTROLLER ON VALVE BOX, SEE SPECS -MASTER VALVE: RAINBIRD PEB VALVE W/ TBOS SOLENOID, SÉE SPECS -MAINLINE, SEE PLAN FOR SIZE – flow — 🛏 CONCRETE BRICKS, ONE AT EACH CORNER -DRAIN ROCK, 3" MIN DEPTH - <u>LEED DECOMMISSIONING</u>: 1. CLOSE GATE VALVE AND CAP OPEN END OF VALVE. 2. REMOVE MASTER VALVE AND COIL WIRES. 3. CAP END OF MAINLINE.

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13 POC/MASTER VALVE
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-REMOTE CONTROL VALVE, SEE PLAN FOR SIZE

VALVE BOX WITH EXTENSIONS AS REQUIRED, SET FLUSH WITH FINISH GRADE - COILED CONTROL AND COMMON WIRES WITH WATERTIGHT CONNECTORS, TYP -LATERAL LINE

CONCRETE BRICK UNDER EACH CORNER OF VALVE BOX, TYP DRAIN ROCK, 4" MIN DEPTH, KEEP BELOW VALVE AND PIPE - PVC BALL VALVE, LINE SIZE -SCH 80 PVC NIPPLE -SCH 40 PVC FITTINGS, TYP

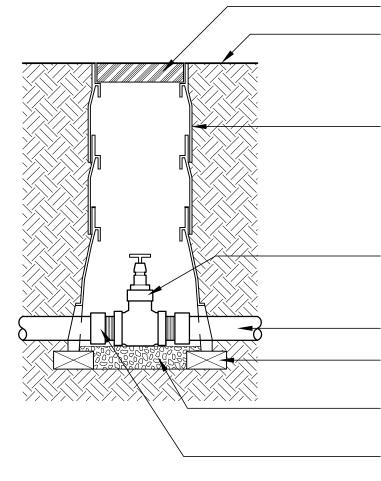

3 GATE VALVE

<u>NOTE:</u> PLUMB HEAD TO BOTTOM

- VALVE BOX WITH LOCKABLE LID, SET FLUSH WITH FINISH GRADE -FINISH GRADE


Section


NTS

-QUICK COUPLING VALVE -DRAIN ROCK, 3" MIN DEPTH -CONC. BRICK, (3) MIN EQ. SP. -SCH 80 PVC NIPPLE. LENGTH AS REQUIRED -(2) SCH 40 STREET ELLS -SCH 80 PVC NIPPLE. LENGTH AS REQUIRED


-SCH 40 PVC TEE OR ELL -SCH 40 PVC STREET ELL - REBAR STAKE, SECURE QUICK COUPLER TO STAKE WITH PIPE CLAMPS, TYP

NOTE: USE TEFLON TAPE ON ALL THREADED CONNECTIONS.

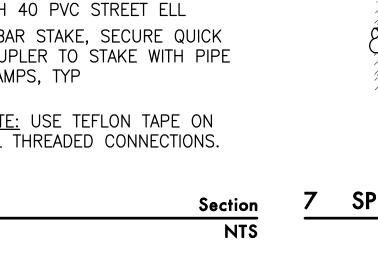

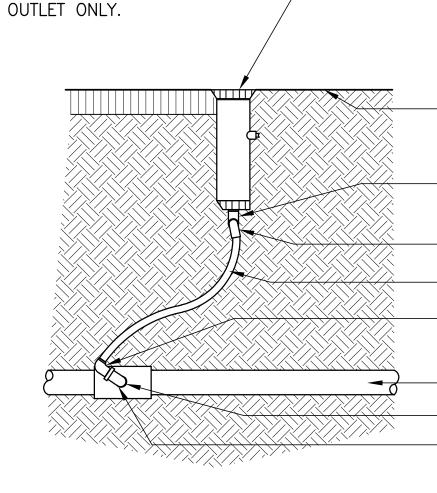

QUICK COUPLER

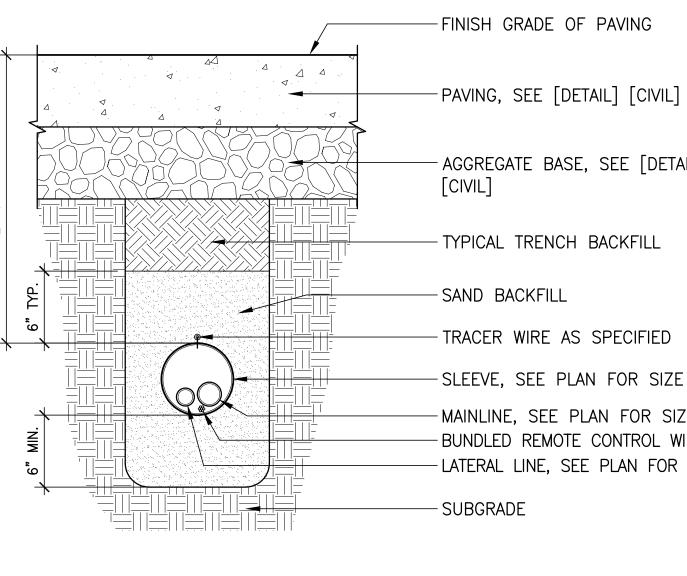


- AGGREGATE BASE, SEE [DETAIL] - TYPICAL TRENCH BACKFILL - SAND BACKFILL - TRACER WIRE AS SPECIFIED -SLEEVE, SEE PLAN FOR SIZE -MAINLINE, SEE PLAN FOR SIZE -BUNDLED REMOTE CONTROL WIRES

-LATERAL LINE, SEE PLAN FOR SIZE - SUBGRADE

Section

NTS



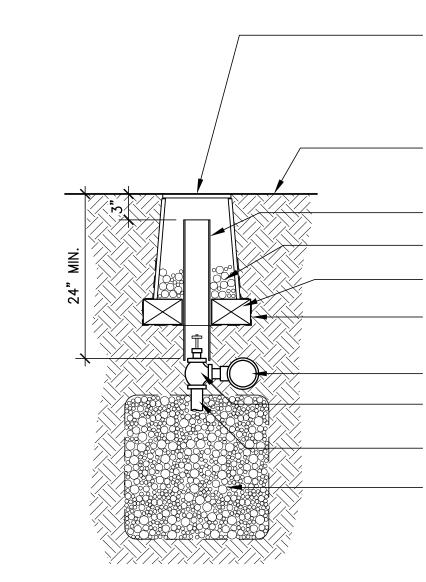

MANUAL DRAIN VALVE

LOCKABLE VALVE BOX LID -FINISH GRADE

10" ROUND VALVE BOX AND EXTENSIONS AS REQUIRED; SET TOP OF BOXES FLUSH WITH FINISH GRADE

BRONZE GATE VALVE, TYP

-MAINLINE, TYP CONCRETE BRICK UNDER EACH CORNER OF VALVE BOX - DRAIN ROCK, 3" MIN DEPTH. KEEP BELOW VALVE AND PIPE -MALE ADAPTERS, BOTH SIDES, TYP

Section

NTS

4 BALL VALVE

- SPECIFIED IRRIGATION HEAD: SET HEAD FLUSH WITH FINISH GRADE AFTER SETTLING (FLUSH WITH MULCH AND 2" ABOVE SOIL IN SHRUB AREAS)

FINISH GRADE

- ¾" BARBED INSERT X ½" MALE THREADED ELBOW

- ½" MARLEX STREET ELBOW -POLY-PIPE SWING JOINT

- ¾" BARBED INSERT X ½" MALE THREADED ELBOW

LATERAL LINE 光" MARLEX STREET ELBOW SCH 40 PVC FITTED WITH THREADED OUTLET

Section NTS

VALVE BOX WITH LOCKABLE LID. IN SHRUB AREAS, SET FLUSH WITH FINISH GRADE OF MULCH AFTER SETTLING. IN TURF AREAS, SET LID FLUSH WITH TURF. -FINISH GRADE

-6" SCH. 40 PVC ACCESS SLEEVE $-\frac{3}{4}$ " DRAIN ROCK, 4" MIN. DEPTH - CONCRETE BRICK, 3 MIN.


WRAP BOTTOM OF VALVE BOX WITH FILTER FABRIC - MAINLINE


- MANUAL DRAIN VALVE WITH SCH 40 FITTINGS -SCH 80 PVC NIPPLE


-2 CU. FT. DRAIN ROCK,

WRAPPED WITH FILTER FABRIC

Section NTS

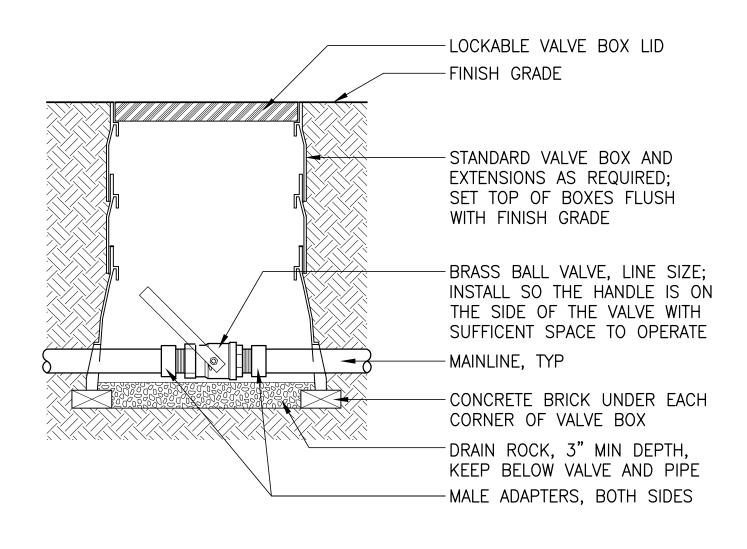

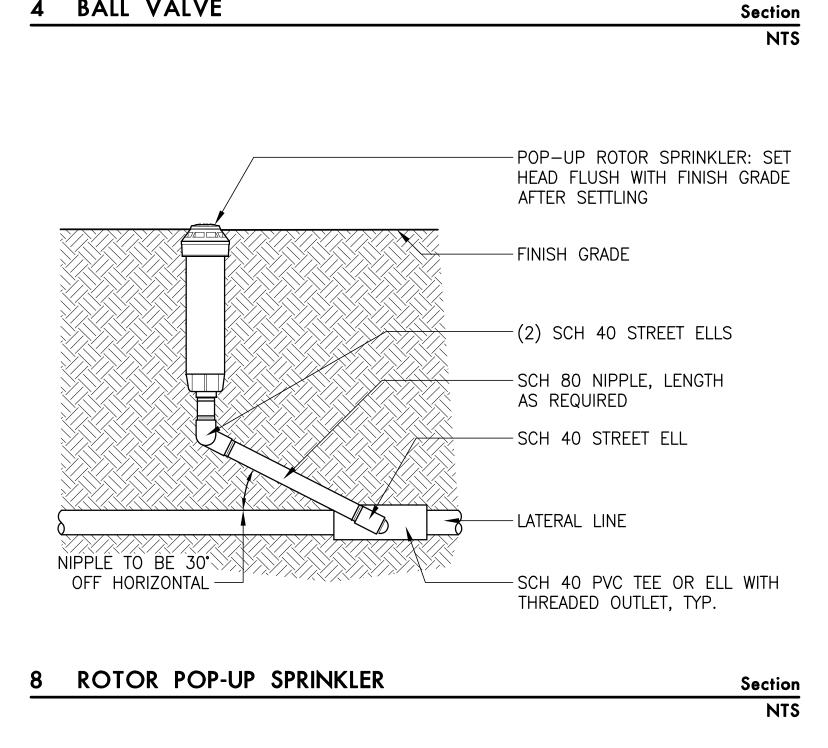

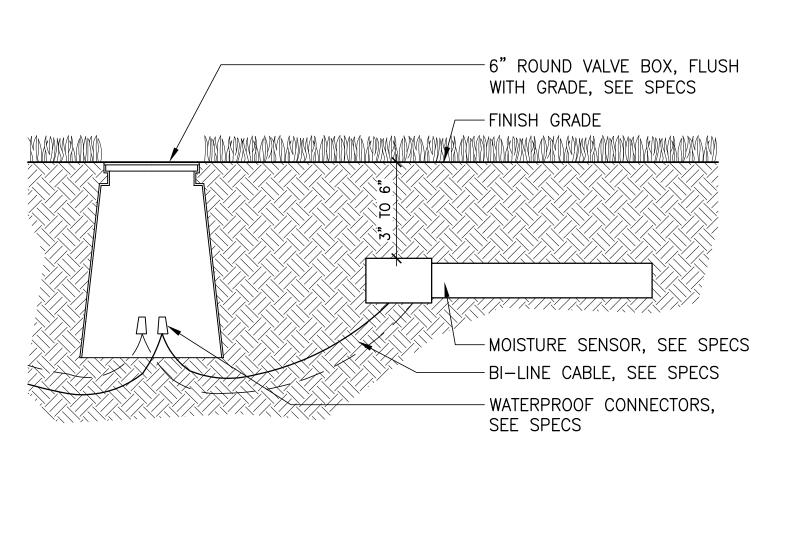

12 SOIL MOISTURE SENSOR

Section NTS

