

PROJECT
CONTRACTOR: US METAL WORKS CONTACT: LYLE DRUCKER PHONE: (503) 668-8036 ARCHITECT: AHHA ARCHITECT, INC. PHONE: (503) 734-8210 SCOPE OF WORK **NEW STEEL BUILDING GENERAL CONDITIONS** 1. THE CONTRACTOR IS RESPONSIBLE FOR CHECKING THE PLANS AND SITE CONDITIONS AND TO NOTIFY THE ARCHITECT OF ANY ERRORS OR OMISSIONS PRIOR TO THE START OF CONSTRUCTION. 2. WRITTEN DIMENSIONS HAVE PRECEDENCE OVER SCALED DIMENSIONS - SEPARATE PLUMBING, ELECTRICAL & MECHANICAL PERMITS AREA REQUIRED SEPARATE PERMITS TO BE OBTAINED BY CONTRACTOR - PLUMBING - ELECTRICAL **CODE SUMMARY:** · BUILDING CODE - 2024 OSSC · FIRE CODE - 2024 OFC · MECHANICAL SPECIALTY CODE - 2024 OMSC · ELECTRICAL CODE - 2024 OESC · PLUMBING CODE - 2024 OPSC · CONSTRUCTION TYPE: TYPE V-B · PER TABLE 503 - TYPE V-B MAXIMUM ALLOWABLE SQ. FT. 9,000 PER STORY, WITH 2 STORIES MAXIMUM. OCCUPANCY CLASSIFICATION: GROUP S-1 · BUILDING AREA IS 6000 S.F. · OCCUPANT LOAD PER TABLE 1004.1.2 - 100 OCCUPANTS PER SF ·TOTAL OCCUPANTS - 6,000 / 300 = 20 OCCUPANTS · PER TABLE 1021.2(2), 2 EXITS REQUIRED, 4 PROVIDED. FLOOR LEVEL CHANGES SHALL NOT EXCEED 1/2". ALL DOOR HARDWARE TO BE ADA APPROVED - 1008.1.9.1 OSSC

PLUMBING REQUIREMENTS

- PLUMBING SHALL NOT CONFLICT WITH REBAR - SEE SHEET TO FOR ALL ADA REQUIREMENTS

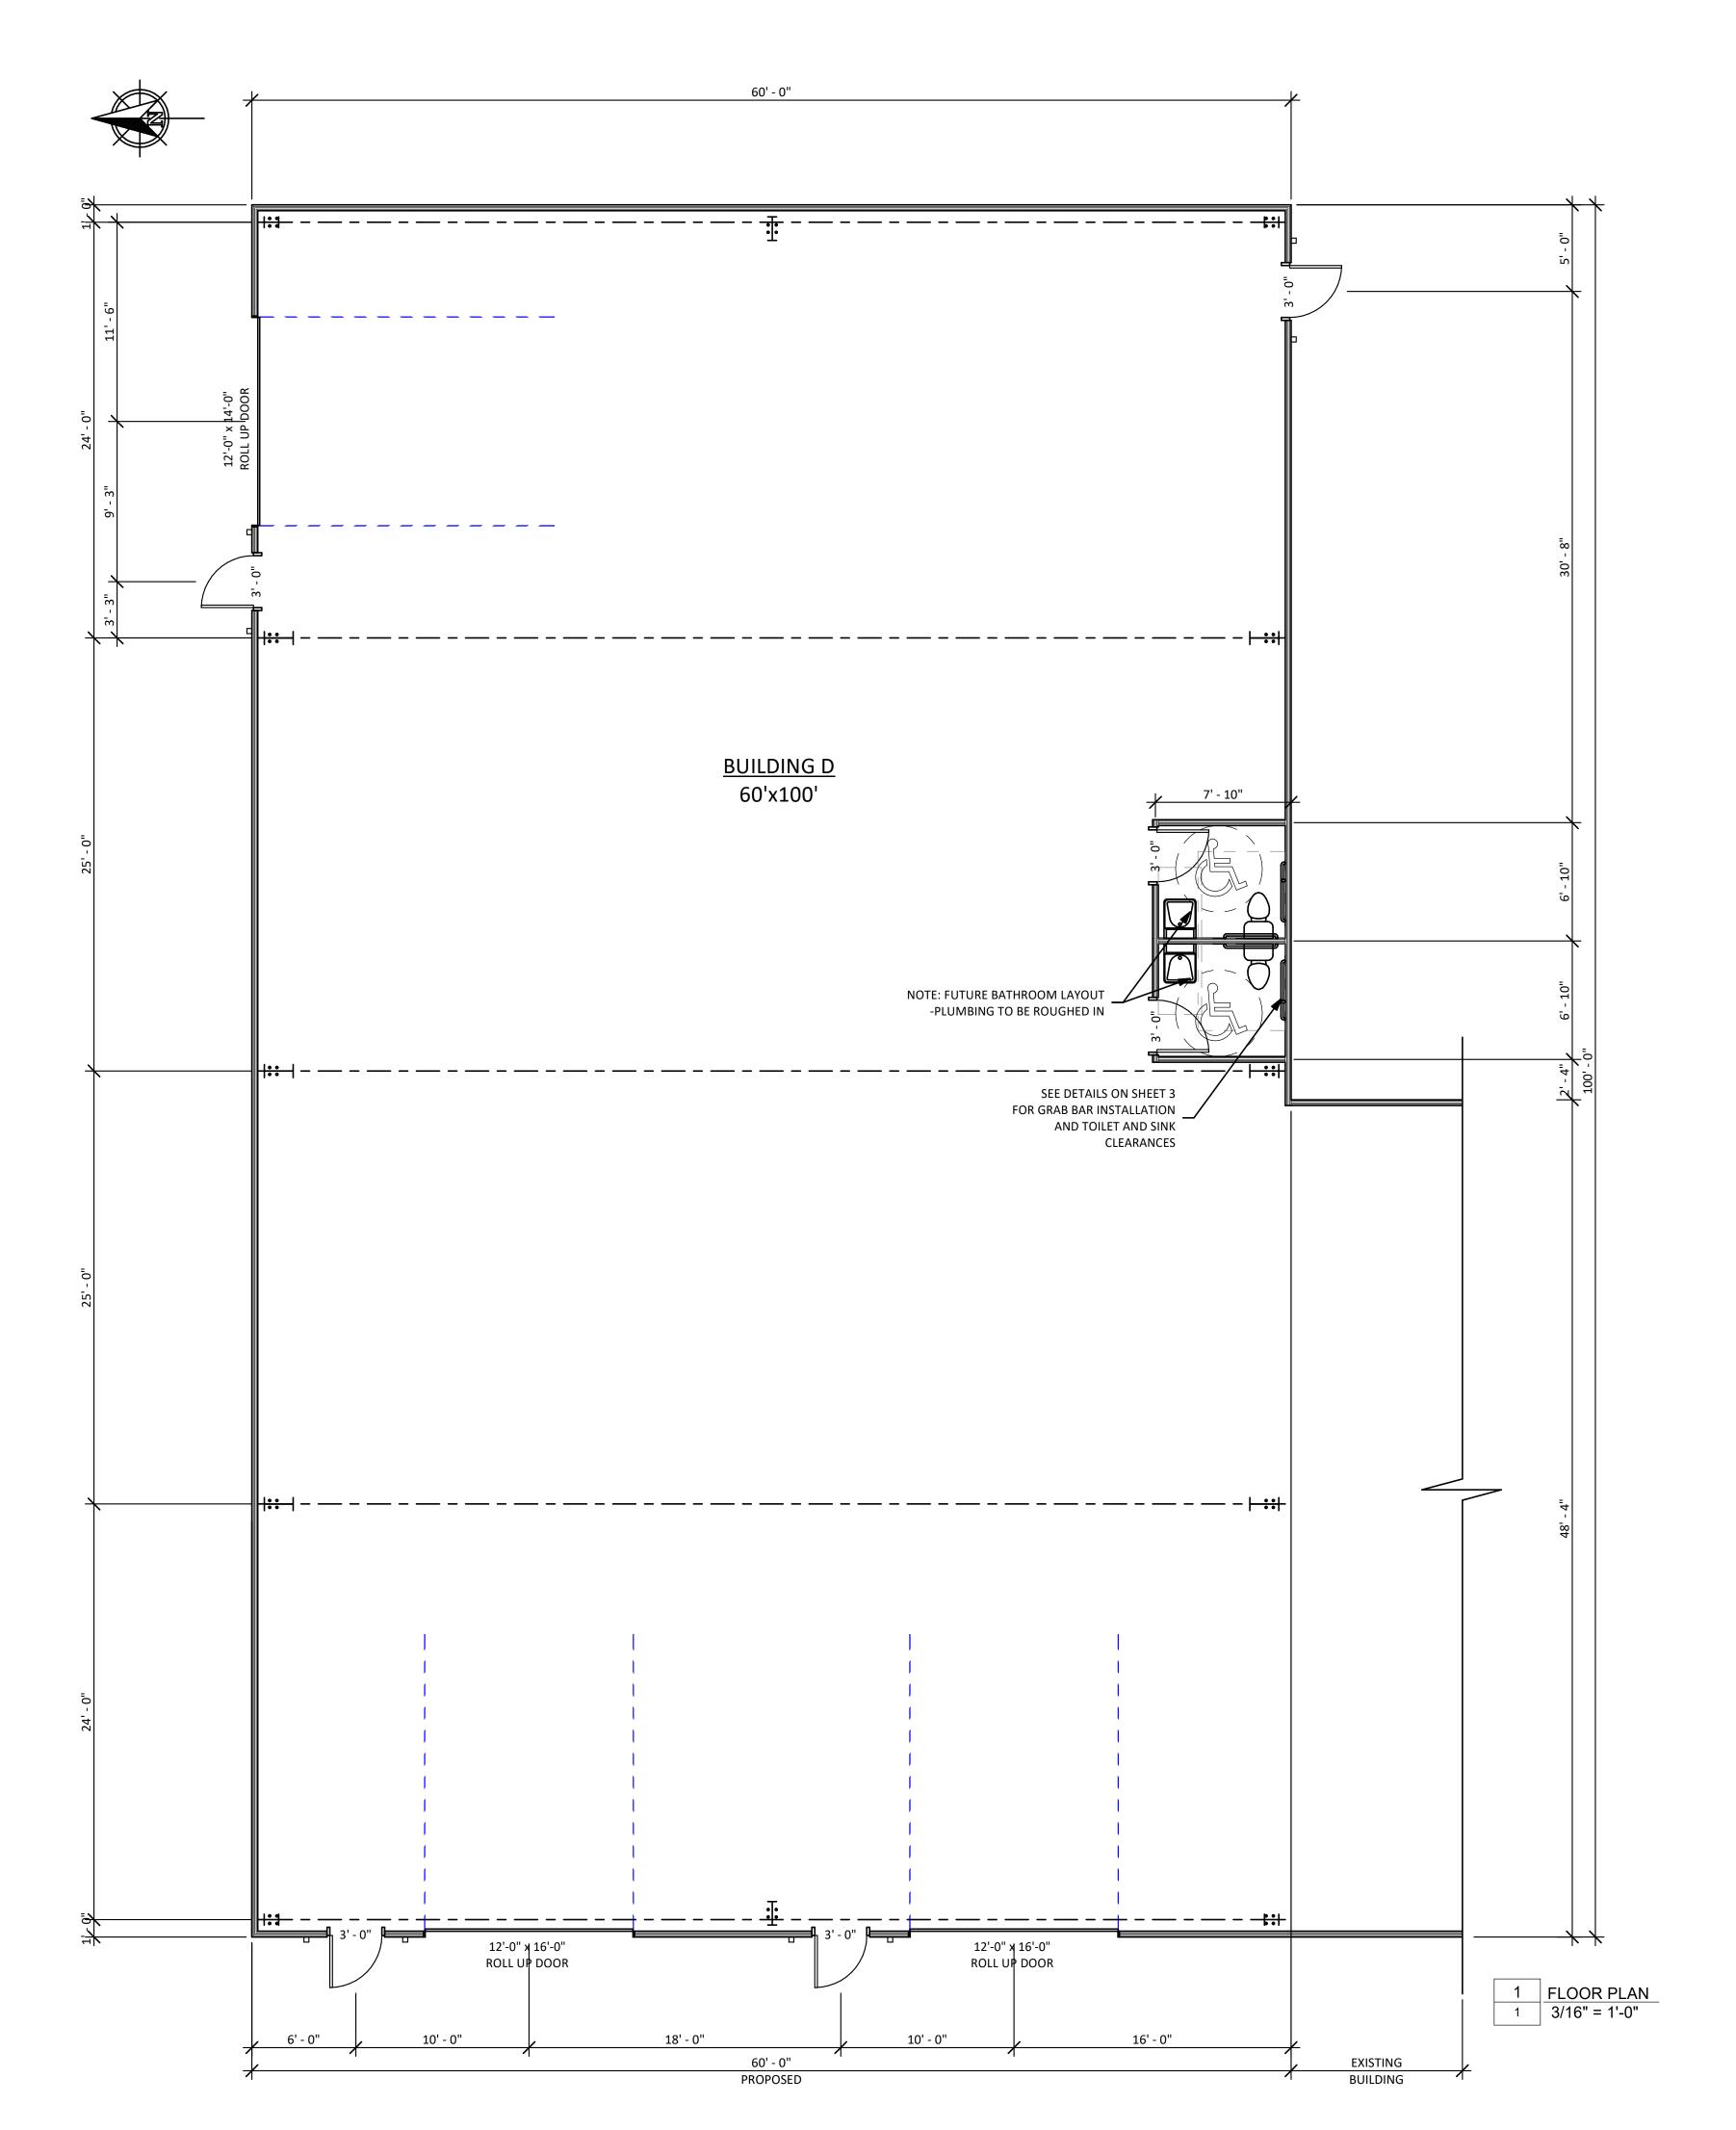

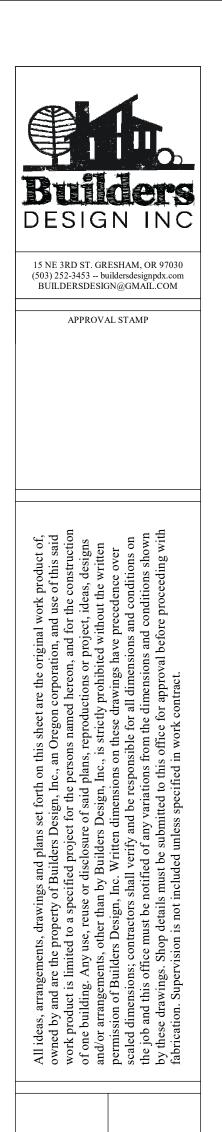

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METAL WORKS
36370 Industrial Way San

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No. Date Issued by


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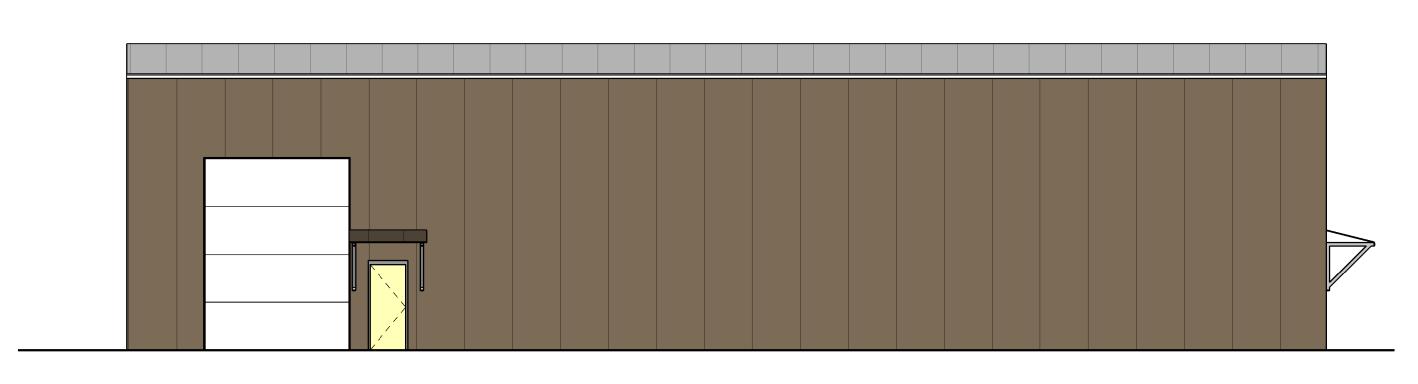
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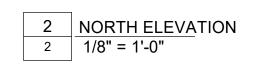
3/16" = 1'-0"


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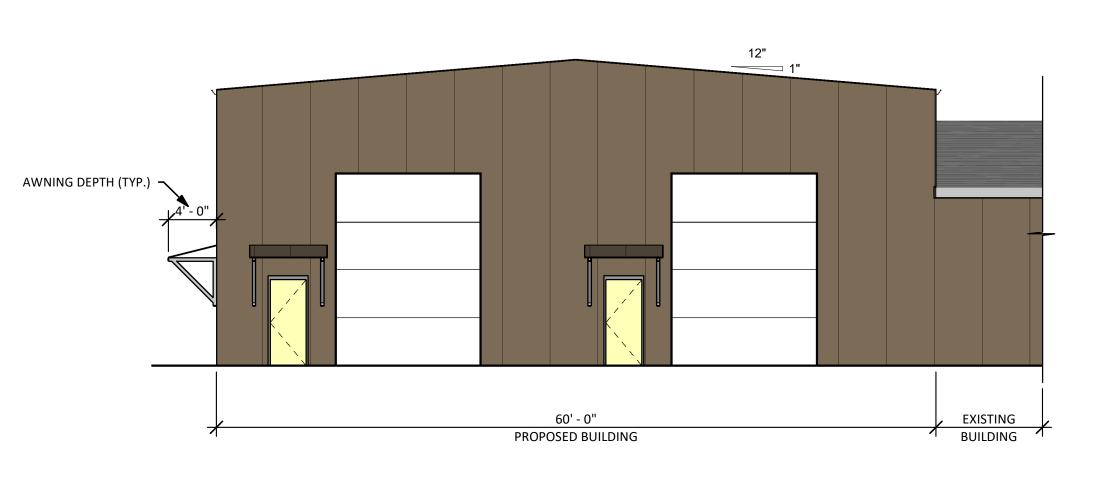
FLOOR







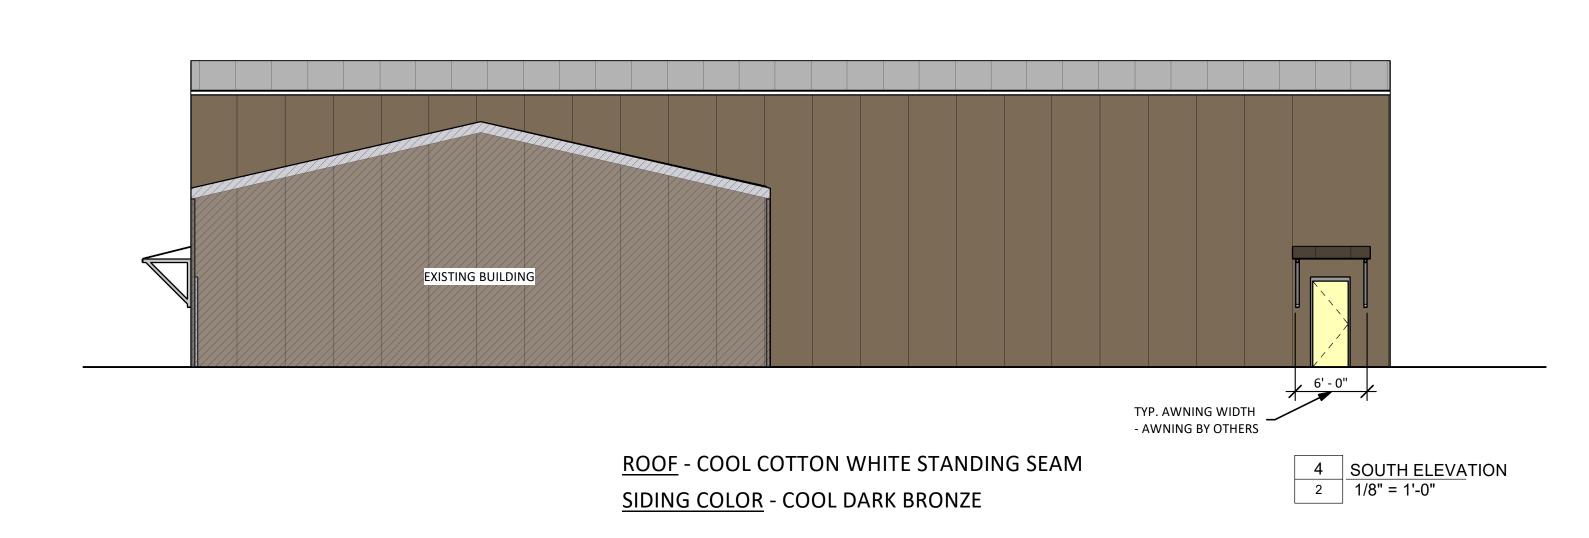

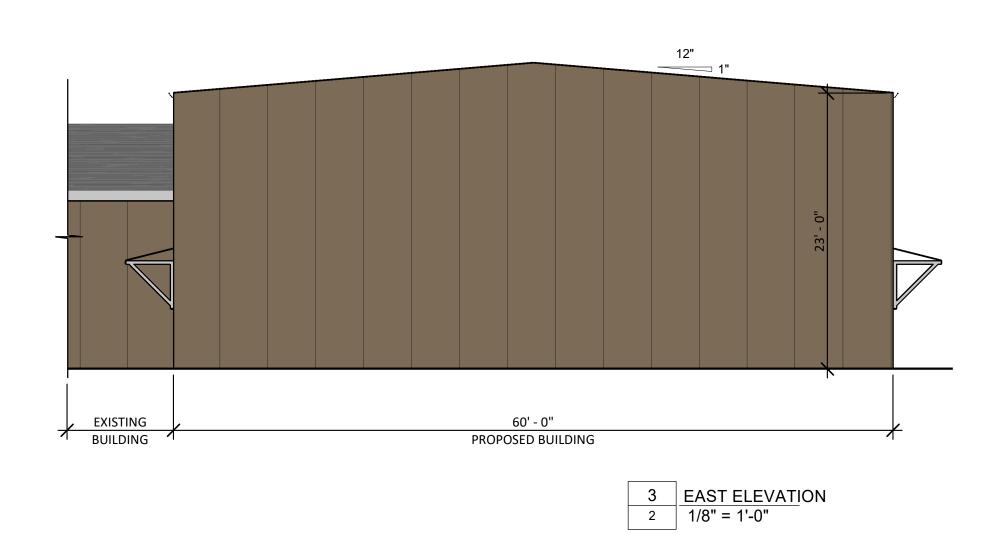

1 WEST ELEVATION 2 1/8" = 1'-0"

Project number: 13750

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Drawn by: KG

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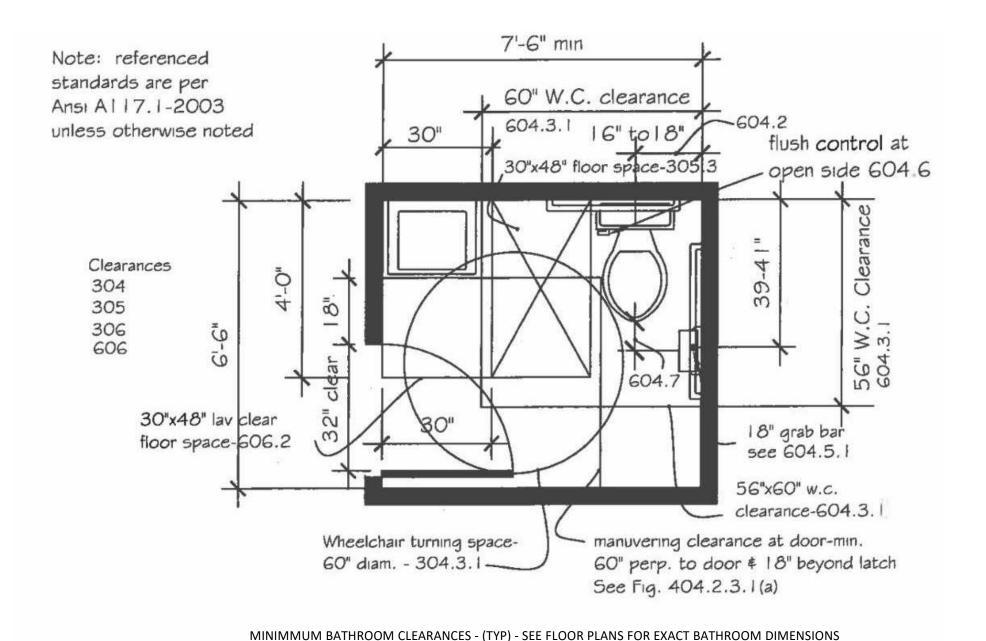
U.S. METAL WORKS - BUILDING 36370 Industrial Way Sandy OR, 97055

ELEVATIONS

15 NE 3RD ST. GRESHAM, OR 97030 (503) 252-3453 – buildersdesignpdx.com BUILDERSDESIGN@GMAIL.COM

APPROVAL STAMP

6,000 ft²
e 1/8" = 1'-0"



Clearances:

REPRODUCTIONS OF THE INFORMATION CONTAINED IN THE ADAAG. REFER TO THE

ADAAG FOR ADDITIONAL INFORMATION.

- 1. Clear floor space shall be 30"x48" 305.3. Clear floor space, clearances at fixtures and turning space shall be permitted to overlap. 603.2.2 (exception: In an individual use room 30" x48" clear floor space is provided within the room beyond the arc of the door swing)- 603.2.3. 2. Clearance around the water closet shall be 60" min. measured perpendicular from side wall, and 56" measured
- measured perpendicular from rear wall 604.3.1. No other fixtures or obstructions are permitted- 604.3.2. 3. 60" diam. turning diam. shall comply with knee and toe clearance requirements. See section 306
- for reduced clearances. 4. Doors and doorways per 404. For latch side approach as shown, min. 48" min. perp. to door \$ 24" clear at latch side. 54" required where closure is provided. See Figure 404.2.3.1. 32" clear
- 1. Front of lavatory shall be 34" max above floor. See ANSI 606.3.
- 2. Knee clearance shall be permitted to extend 25" max under lav at 9" above floor. Where knee clearance is part of required ground space, the knee clearance shall be 11" deep min. at 9" above floor and 8" deep, min. at 27" above floor. 306.3.2 and 306.3.3. See 306.3.4 for reduced clearances.
- 3. Verify that lav choosen will meet W.C. clearance and knee and toe space requirements.

Water Closet:

Lavatories:

- Clearances per 604.3. Height per 604.4- see Figure 604.4.
- 2. Grab bars per 604.5 Figure 604.5.1 and Figure 604.5.2.
- 3. Flush control- hand-operated or automatic- 604.6. If hand-operated, it shall be operable with one hand and shall not require tight grasping. Max. 5 pound operating force to activate. See 309.4.
- 4. Toilet paper dispensers per 604.7 \$ 309.4. 7" min. and 9" max. in front of water closet. Outlet of dispenser-min. I 5" and max 48" above floor.

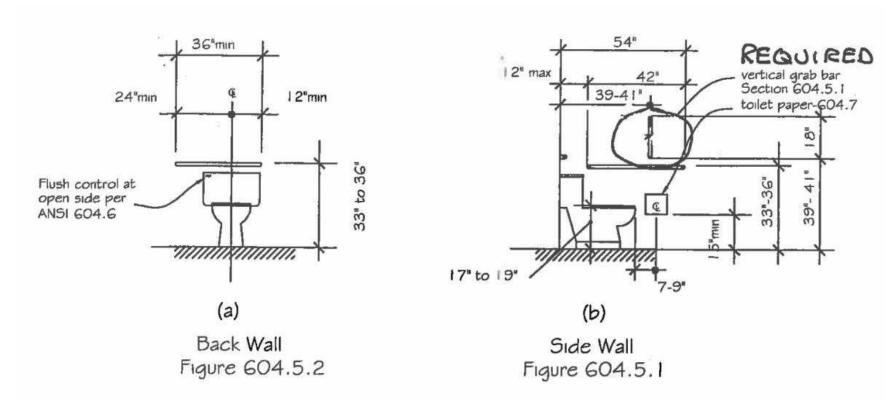


Figure 2 Grab Bars at Water Closets

ANSI 604.5

(a) Back wall elevation. A 36" minimum length grab bar is required behind the water closet mounted at a height between 33" and 36"-Fig. 604.5.2. The grab bar must extend a munimum of 12" beyond the center of the water closet toward the side wall and a minimum of 24" toward the open side for either a left or right side approach. See Section 604.5.2.

- (b) Side Wall. A 42" minimum length grab bar is required to the side of the water closet spaced | 2" maximum from the back wall and extending a minimum of 54" from the back wall at a height between 33" to 36"- Figure 604.5.1. The toilet paper dispenser outlet mounted at 15" minimum and 48" maximum above the floor. See Section 604.7.
- (c) Flush controls shall be hand operated or automatic. Hand operated flush controls shall comply with Section 309. Flush controls shall be located on the open side of the water closet.

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APPROVAL STAMP

BUILDING 708, 97055 DETAIL 36370 Industrial Way

WORKS

METAL

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No. Date Issued by

Project number: Date: 6/12/2025 10:21:30 AM Drawn by:

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1/4" = 1'-0"